BERNARDS TOWNSHIP ENVIRONMENTAL COMMISSION Regular Meeting of February 22, 2021-7 pm

The Environmental Commission meeting for February 22, 2021 will be conducted using Zoom Video Conferencing. The public will be able to view the meeting live by clicking on this link https://us02web.zoom.us/j/89453197130?pwd=bDU5aFA3YXYvWm15L0V2a2JXa0N2dz09 at 7:00 PM

Or by calling 1-646-558-8656 and entering Meeting ID: 894 5319 7130 and Passcode: 034175 Public comment will be accepted via e-mail. Please include your name and address in the e-mail and send comments to kcartoccio@bernards.org. They will be read during the public comment section.

Meeting Agenda

- 1. Call to Order
- 2. Open Public Meeting Statement
- 3. Flag Salute
- 4. Roll Call
- 5. Approval of EC Meeting Minutes Regular and Reorganization January 25, 2021
- 6. Reports and Miscellaneous Correspondence
 - a. Correspondence
 - i. 16 Rocky Ln-NJDEP-FWW General Permit #8
 - ii. PSE&G -FWW Permit Extension
 - b. Public Outreach Project Update
- 7. Old Business
 - a. Silver Living-ZB20-015 14 North Maple Ave-Revised Materials.
- 8. New Business
 - a. Applications *Note-Verizon & Fellowship SL have separate links*
 - i. **Verizon Corporate Services Group-ZB21-001 300 North Maple Ave-** Major site plan approval for construction of additional parking.
 - ii. Roti-ZB21-002 10 Pacer Ct-6' fence in front yard; Shed in front yard.
 - iii. <u>Burcat-ZB21-005 153 Spencer Rd</u>-Variance for front yard setback (addition) and a pool not located behind rear building line of adjacent dwellings.
 - iv. Rosentblatt-ZB21-006 30 Cameron Ct- Pool not located behind the rear building line of adjacent dwellings.
 - y, **Fellowship Senior Living-PB20-005 8000 Fellowship Rd-** Preliminary & final major site plan.
 - 9. Comments by Public
- 10. Comments by Members
- 11. Adjournment

Kelly Julian, Secretary

Please call (908) 204 - 3000 seventy-two (72) hours in advance if accommodations are required, including assistive listening devices (ALD).





BERNARDS TOWNSHIP ENVIRONMENTAL COMMISSION MINUTES – January 25, 2021 – 7pm

CALL TO ORDER

Chairperson Ann Parsekian called the meeting to order at 7:11 pm via Zoom Conference call in accordance with the Open Public Meeting Act of 1975.

FLAG SALUTE

All those assembled saluted the flag.

ROLL CALL

Present: Joan Bannan, Debra DeWitt, Nancy Cook, Jane Conklin, James LaMaire, Ann

Parsekian, Jason Roberts, Alice Smyk, Sarah Wolfson

Absent: Emily Johnston Schlenker

Also Present: Kaitlin Cartoccio - Recording Secretary, Todd Edelstein - Resident, John Crane

- Resident

APPROVAL OF MEETING MINUTES

Motion to approve the December 28, 2020 minutes made by Debra DeWitt, second by Nancy Cook. Sarah Wolfson and Jason Roberts abstained. All in favor, motion carried.

REPORTS & MISCELLANEUS CORRESPONDENCE

a. 3066 & 3074 Valley Road - LOI

No comments.

b. Year End Report for 2020

Sarah Wolfson commented that "wildlife" was included in "flora and fauna". Wildlife will be taken out and flora and fauna would be kept in the report. Alice Smyk made motion to approve the report, Jane Conklin seconded. All those in favor, motion carried.

NEW BUSINESS

a. Rossi-ZB-21-003-14 Culberson Road – "C" Coverage Variance for construction of an inground pool. Patio & cabana.

Debra Dewitt recused herself at 7:18 pm. The Environmental Commission notes the proposed lot coverage exceeds the required amount. Increased impervious coverage increases the volume (quantity) of stormwater runoff, which can contribute to local and potentially area wide flooding. Site drainage is the concern with this application, therefore site features to promote stormwater infiltration should be considered. The New Jersey Department of Environmental Protection Green Infrastructure website is a good reference for "green" stormwater management practices for homeowners (http://www.nj.gov/dep/gi/). The Commission suggests that the applicant may want to consider reducing the amount of impervious surface coverage. In regards to this application, pool water discharge may result from backwashing of filters, or from the draining of swimming pools at the end of season, or during maintenance. This water





often contains pool treatment chemicals that can cause damage to the receiving environment in the form of non-point source pollution. Therefore, the Environmental Commission wants township residents to use the best management practices available when discharging pool water.

Motion by James LaMaire, seconded by Nancy Cook.

All in favor, motion carried.

b. Maschhoff-ZB-21-004-31 Clairvaux Ct – "C" Variances for in ground pool coverage – Not behind rear building line of adjacent dwelling

Debra DeWitt returned at 7:40 pm. The Environmental Commission notes the proposed lot coverage exceeds the required amount. Increased impervious coverage increases the volume (quantity) of stormwater runoff, which can contribute to local and potentially area wide flooding. Site drainage is the concern with this application, therefore site features to promote stormwater infiltration should be considered. The New Jersey Department of Environmental Protection Green Infrastructure website is a good reference for "green" stormwater management practices for homeowners (http://www.nj.gov/dep/gi/). In regards to this application, pool water discharge may result from backwashing of filters, or from the draining of swimming pools at the end of season, or during maintenance. This water often contains pool treatment chemicals that can cause damage to the receiving environment in the form of non-point source pollution. Therefore, the Environmental Commission wants township residents to use the best management practices available when discharging pool water. The Commission also wants to note that if the pool is placed in accordance with the ordinance, trees would have to be removed. The proposed plan does not appear to require tree removal.

Motion by Jane Conklin, seconded by Debra DeWitt.

All in favor, motion carried.

c. Fellowship Village-PB-20-005-8000 Fellowship Rd – Preliminary & final major site plan.

Alice Smyk recused herself at 7:57 pm. Discussion tabled to February meeting.

Motion by Debra DeWitt, seconded by Nancy Cook.

All in favor, motion carried.

Alice Smyk returned at 7:58 pm.

PUBLIC COMMENT

Todd Edelstein mentioned a conversation with Dave Schley, met with Pat Monaco about the packet with the social security number. Suggested that new people should attend Zoning Board or Planning Board meeting. John Crane was glad to see Ann and Debra reappointed. Told new





members to reach out if they should need anything.

COMMENTS BY MEMBERS

Ann Parsekian asked the new members what kind of project they were interested in. Sarah Wolfson replied being interested in eliminating invasive species. Jason Roberts said he is excited for the opportunity to be a part of the Environmental Commission. Ann Parsekian then brought up a membership for the Association of New Jersey Environmental Commission. The Bernards EC has not been a member for several years. 7 members get free training from ANJEC, and ANJEC has displays and activities to loan members. In addition, there are grants and other opportunities for ECs that are members. The Commission voted unanimously to renew their membership. The Commission also received mail from Brian Pinke, an NJ Watershed Ambassador. He will be invited to an upcoming meeting. Last year the EC had 2 committees – Charter Day and Social Media. Debra DeWitt and Nancy Cook will continue on the social media committee. Ideas included a composting video and a community project. There was a discussion on either purchasing or acquiring donated monarch buttery milkweed seeds to distribute to residents.

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ADJOURNMENT

Meeting was adjourned at 8:53 pm. Motion by James LaMaire, second by Joan Bannan. All in favor, motion carried.

Respectfully submitted, Kaitlin Cartoccio, Meeting Secretary



TO: Zoning Board Chairperson and Members

FROM: Ann Parsekian, Chairperson

Bernards Township Environmental Commission

DATE: January 26, 2021

RE: Applications review

The Environmental Commission reviewed these applications at their January 26, 2021 meeting and forwards the following comments.

Zoning Board

Rossi ZB21-003 14 Culberson Road

The Environmental Commission has reviewed this application and offers the following comments:

- 1. The Environmental Commission notes the proposed lot coverage of 22.54% substantially exceeds the permitted maximum of 18%. Increased impervious coverage increases the volume (quantity) of stormwater runoff, which can contribute to local and potentially area-wide flooding. Site drainage is a concern with this application, therefore site features to promote stormwater infiltration are important. The NJ DEP Green Infrastructure website is a good reference for "green" stormwater management practices for homeowners. (http://www.nj.gov/dep/gi/).
- 2. The Commission suggests that the Zoning Board discuss with the Applicant whether they may want to consider reducing the amount of impervious surface coverage.
- 3. The site plan depicts low walls around portions of the patio and fire pit areas, and also appears to show existing shrubbery/trees between the patio and fire pit areas and the proposed pool area. There does not seem to be a clearly defined path/walk to access the pool area. The Environmental Commission suggests that the Zoning Board clarify proposed access with the Applicant.
- 4. With regard to this application, pool water discharge may result from backwashing of filters, or from the draining of swimming pools at the end of season or during maintenance. This water often contains pool treatment chemicals that can cause damage to the receiving environment. Therefore, the Environmental Commission wants township residents to use the best management practices available when discharging pool water.



https://www.bernards.org/government/documents/department-documents/environmental/1645-best-management-practices-pool-water-discharge/file

Maschoff ZB21-004 31 Clairvaux Court

The Environmental Commission has reviewed this application and offers the following comments:

- 1. The Environmental Commission notes that at 18.1% the proposed lot coverage substantially exceeds the permitted maximum of 15%. Increased impervious coverage increases the volume (quantity) of stormwater runoff, which can contribute to local and potentially area-wide flooding. Site drainage is a concern with this application, therefore adequate site features to promote stormwater infiltration are important. The NJ DEP Green Infrastructure website is a good reference for "green" stormwater management practices for homeowners. (http://www.nj.gov/dep/gi/).
- 2. The Commission suggests that the Zoning Board discuss with the Applicant whether they may want to consider reducing the amount of impervious surface coverage.
- 3. With regard to this application, pool water discharge may result from backwashing of filters, or from the draining of swimming pools at the end of season or during maintenance. This water often contains pool treatment chemicals that can cause damage to the receiving environment. Therefore, the Environmental Commission wants township residents to use the best management practices available when discharging pool water. https://www.bernards.org/government/documents/department-documents/environmental/1645-best-management-practices-pool-water-discharge/file
- 4. The Environmental Commission notes that placement of the pool within the area permitted by ordinance, as shown on the submitted Proposed Landscape Development plan to be south of the proposed location, would apparently require the removal of a number of existing trees. It would be preferable to minimize tree removal.

Cc: David Schley, Township Planner Cyndi Kiefer, Secretary; for distribution to BOA members





BERNARDS TOWNSHIP ENVIRONMENTAL COMMISSION REORGANIZATION MEETING MINUTES – January 25, 2021 – 7pm

CALL TO ORDER

Chairperson Ann Parsekian called the meeting to order at 7:01 pm via Zoom Conference call in accordance with the Open Public Meeting Act of 1975.

FLAG SALUTE

All those assembled saluted the flag.

ROLL CALL

Present: Joan Bannan (7:02 pm), Debra DeWitt, Nancy Cook, Jane Conklin (7:04pm),

James LaMaire, Ann Parsekian, Jason Roberts, Alice Smyk, Sarah Wolfson

Absent: Emily Johnston Schlenker

Also Present: Kaitlin Cartoccio - Recording Secretary, Todd Edelstein - Resident, John Crane –

Resident

REVIEW TOWNSHIP ORDINANCE FOR ENVIRONMENTAL COMMISSION

Ann Parsekian had sent out copies of the Environmental Commission's mission and objectives. No changes have occurred in the ordinance governing the Environmental Commission.

NOMINATION FOR CHAIRPERSON

Motion by Nancy Cook, seconded by Debra DeWitt to nominate Ann Parsekian as Chairperson of the Environmental Committee. No other nominations were heard. All were in favor, motion passed.

NOMINATION FOR VICE CHAIRPERSON

Motion by Nancy Cook, seconded by Alice Smyk to nominate Debra DeWitt as Vice Chairperson of the Environmental Committee. No other nominations were heard. All were in favor. Motion passed.

SUB-COMMITTEE APPOINTMENTS

Alice Symk nominated herself for Environmental Commission representative on the Tree Protection Committee. No other nominations were heard. All were in favor. Motion passed.

COMMENTS BY MEMBERS

Debra Dewitt was asked to be on Agricultural Advisory Committee as part of the Environmental Commission.

ADJOURNMENT

Meeting was adjourned at 7:11pm. Motion by Debra DeWitt, second by Jane Conklin. All in favor, motion carried.

Respectfully submitted, Kaitlin Cartoccio, Meeting Secretary

PK ENVIRONMENTAL

Planning & Engineering
PO Box 1066, 205 Main Street
Chatham, New Jersey 07928

Sandra E. Kehrley, PE, CFM John P. Peel, PP

tel (973) 635-4011 fax (973) 635-4023

PUBLIC NOTICE

NJDEP Freshwater Wetlands (FWW) General Permit #8

TO:

Bernards Township Clerk, Bernards Township Construction Official, Bernards Township

Environmental Commission, Bernards Township Planning Board, Somerset County Planning Board,

and Property Owners Within 200-Feet of Block 3602 Lot 7 in Bernards Township

DATE: January 29, 2021

RE:

NJDEP Freshwater Wetlands (FWW) General Permit #8 Application

Block 3602 Lot 7 (16 Rocky Lane)

Bernards Township, Somerset County, NJ

Applicant/Owner: Michael Davidson

This letter provides you with legal notification that Michael Davidson has submitted an application to the NJDEP Division of Land Resource Protection for authorization of a Wetlands General Permit #8 for construction of a detached 720-square foot barn/shed building within an NJDEP regulated wetland/transition area. Also enclosed is a copy of the "Site Plan – Davidson Barn/Shed", prepared by Titus Surveying & Engineering P.C.

The NJDEP welcomes comments and any information that you may provide concerning the proposed on-site septic improvements, and if there are any comments or questions regarding this application, please submit your written comments to the address below.

NJDEP Division of Land Resource Protection Mail Code 501-02A, PO Box 420 Trenton, NJ 08625-0420 Attn: Somerset County Supervisor

Sincerely,


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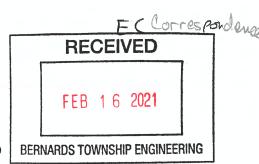
CC:

NJDEP DLRP

Michael Davidson (Owner/Applicant)

CERTIFIED MAIL



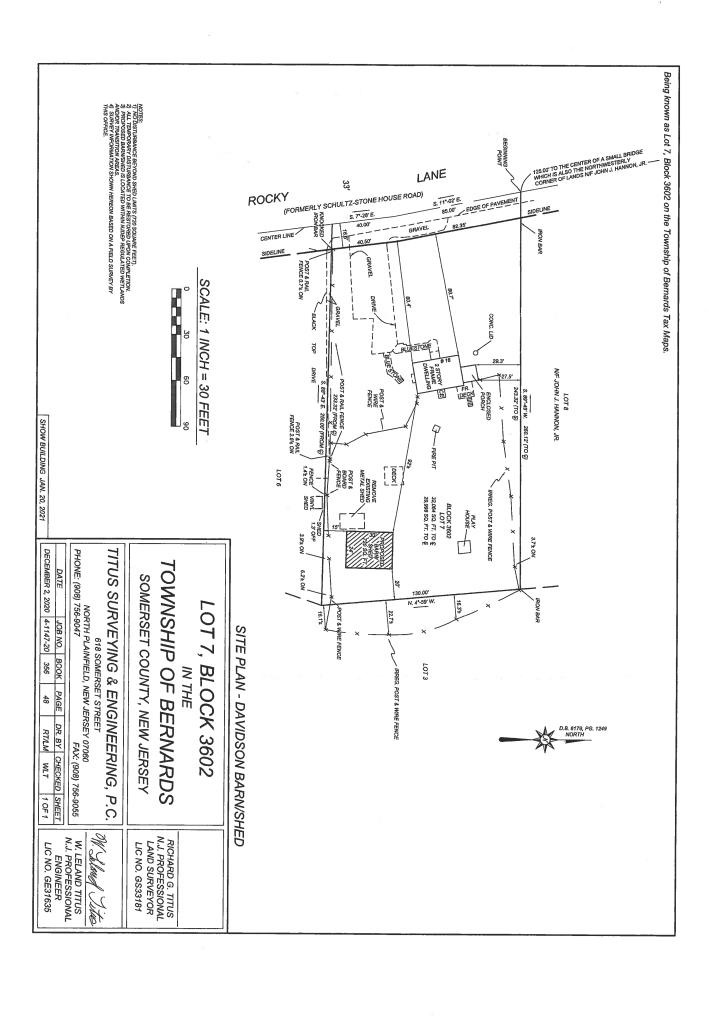

Delivery Projects & Construction

Public Service Electric and Gas Company

4000 Hadley Road, South Plainfield, New Jersey 07080



November 30, 2020

Notice to: Construction Official, Environmental Commission, Planning Board, County Planning Board, and County Soil Conservation District

CERTIFIED MAIL

Re: Application for an Extension of Freshwater Wetlands General Permit Number 1
PSE&G Electric Overhead and Underground Transmission System ROWs Maintenance
Bergen, Burlington, Camden, Essex, Gloucester, Hudson, Hunterdon, Mercer, Middlesex,
Morris, Passaic, Salem, Somerset, Sussex, Union, and Warren Counties, New Jersey
File No. 0000-02-0031.2, FWW160001

To Whom It May Concern:

This letter is to provide you with legal notification that an application for an Extension of a Freshwater Wetlands General Permit Number 1 (FWW GP1) has been submitted to the New Jersey Department of Environmental Protection, Division of Land Use Regulation for the maintenance of existing Public Service Electric and Gas Company (PSE&G) Electric Overhead and Underground Transmission System Rights-Of-Way, as shown on the enclosed map. A brief description of the proposed project follows:

PSE&G is required to maintain its regional electric transmission system on an ongoing basis in an effort to provide safe and reliable electric service to its approximate 2.2 million customers by the New Jersey Board of Public Utilities (BPU) and the North American Electric Reliability Corporation (NERC). This activity has been previously permitted under a "blanket" FWW GP1, issued on April 5, 2016 and set to expire on April 4, 2021 (NJDEP Permit No. 0000-02-0031.2, FWW160001). The FWW GP1 authorizes the disturbance of wetlands and State open waters necessary to perform temporary and routine maintenance and repair activities within the PSE&G Electric Overhead and Underground Transmission System Rights-of-Way including: vegetation management and maintenance; access road repair, rehabilitation or replacement; maintenance and/or reconstruction; tower and pole foundations inspections and repairs; reconductoring; and repair of underground insulation and shield tapes. The FWW GP1 also authorizes the emergency repairs within wetlands and State open waters necessary to restore service to affected areas.

The complete permit application package can be reviewed at either the municipal clerk's office or by appointment at the Department's Trenton Office. In addition, an electronic copy of the initial application can be provided via an OPRA request by contacting https://www.nj.gov/dep/opra/opraform.html from the Department's Trenton Office. The Department of Environmental Protection welcomes comments and any information that you may

Government Officials November 30, 2020 Page 2

provide concerning the proposed maintenance activities. Please submit your written comments within 45 calendar days of the date of this letter to:

New Jersey Department of Environmental Protection Division of Land Use Regulation Mail Code 501-02A P.O. Box 420 Trenton, New Jersey 08625 Attention: Application Support

If you have any questions regarding this notice, please feel free to contact me.

Very truly yours,

Public Service Electric and Gas Company

David W. Grossmueller, Ph.D.

Senior Permitting Specialist

PSE&G Delivery Projects & Construction


4000 Hadley Road

South Plainfield, New Jersey 07080

(908) 412-7257

DWG/kt enclosures

cc: NJDEP Application Support

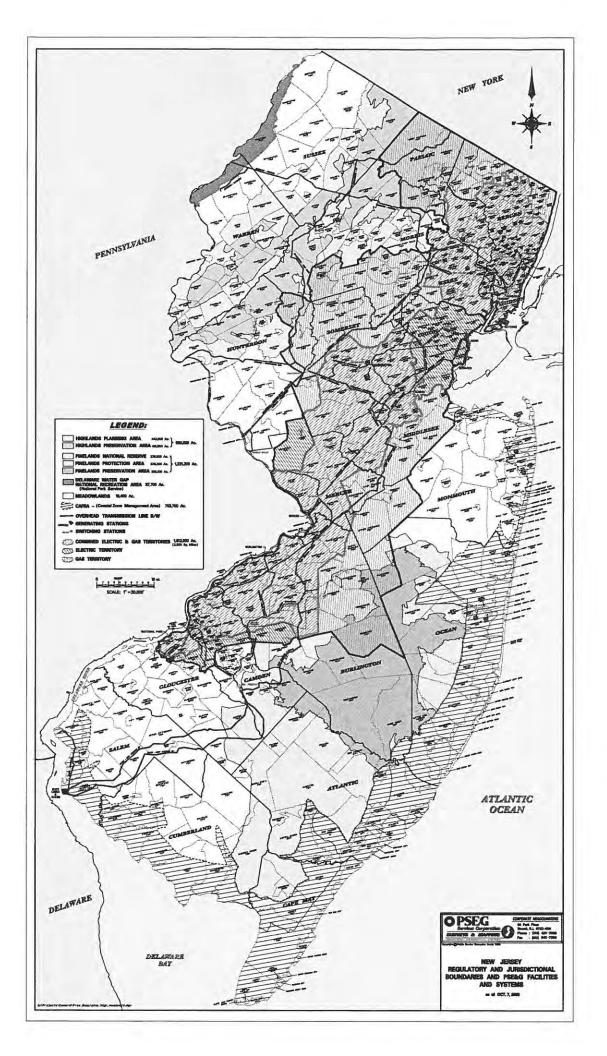

7/3 REVIGED MAIERIALS TOWNSHIP OF BERNARDS

TOWNSHIP OF BERNARDS ZONING BOARD OF ADJUSTMENT APPLICATION STATUS FORM

Application No: <u>Z520.015</u> Block: <u>1607</u> Lot: <u>2</u> Zone: <u>2-7</u>				
Applicant: SILVERLIVING LLC				
Address of Property: 14 NONTLI MAPLE AVENUE				
Description: BULK VARIANCES + MAX LOT COVERAGE				
TO RAZE EXISTING STRUCTURE ? REPLACE WITH				
NEW HINGLE FAMILY DWELLING				
APPLICATION CHECKLIST				
Original + 16 copies of Application W-9 Site Visit Consent (A) Ownership Form (B) 200' Property Search List (C) Tax Certification (D) Notice to be Served (E) Notice to be Published (F) Dimensional Statistics Form (G) Contributions Disclosure Form (H) Engineering Plan/Plot Plan Architectural Plans Survey Photographs Wetlands Report/LOI Application Fee Escrow Deposit Imaging Fee Tax Map Revision Fee Checklist				
SCHEDULING HEARING				
Original Submission Date Original Submission Date Completeness Deadline (45 days) Incomplete Date Resubmission Date Date Complete Date Complete Time to Act (45/95/120 days) Original Submission Date (45 days) Date of Publication Completeness Hearing Public Hearing Carried to Date CARRIED TO DATE CARRIED TO DATE CARRIED TO DATE				
*COVID DEADLINES DISTRIBUTION NOTES				
Environmental Comm Fire Official LCFAS Police				

Bisogno, Loeffler & Zelley, L.L.C.

Attorneys at Law 88 South Finley Avenue Post Office Box 408 Basking Ridge, New Jersey 07920

Vincent T. Bisogno

vbisogno@baskingridgelaw.com
Paul H. Loeffler (Member N.J. & N.Y. Bars)

ploeffler@baskingridgelaw.com

Frederick B. Zelley (Member N.J. & Pa. Bars)

fzelley@baskingridgelaw.com

Paul D. Mitchell pmitchell@baskingridgelaw.com Telephone:

(908) 766-6666

Facsimile:

(908) 766-7809

January 29, 2021

Ms. Cynthia Kiefer, Administrator Bernards Township Board of Adjustment 277 South Maple Avenue Basking Ridge, New Jersey 07920

Via Hand Delivery

Re:

Application for Bulk Variances

Applicant: Silver Living LLC

Tax Block 1607, Lot 2 – 14 North Maple Avenue

Dear Ms. Kiefer:

As you know, this office represents Silver Living LLC, the Applicant in the above referenced Application, which is presently scheduled to be heard by the Board of Adjustment on Wednesday, March 3, 2021.

In view of the Board's comments at the first hearing and discussions with the objecting neighbor's attorney, our team has revised the architectural and engineering plans. The revised plans reflect improvement as to the following:

- 1. Proposed Impervious Coverage (decreased from 37.4% to 32.5%);
- 2. Proposed Rear Yard Setback (increased from 20.5' to 23.8');
- 3. Side Yard Setback (increased from 18.7' to 22.1'); and
- 4. Increase in the distance of the proposed retaining wall from the objecting neighbor's property line, from less to 5' to more than 20'.

The revised plans do reflect a decrease in the North Maple Avenue Front Yard Setback 28.0'), but we believe this to be an acceptable setback given the fact that the proposed ces East Allen Street not North Maple Avenue.

Enclosed herewith please find the following:

- Revised Dimensional Statistics Sheet (17)
 - Revised Engineering Plans by Murphy & Hollows Associates (3 Sheets) (17 Sets)
- Revised Architectural Plans by Battersby Architecture and Design (6 Sheets) (17

Thank you for your attention and anticipated continued cooperation in this matter. you have any questions or concerns, or if we may otherwise be of any further assistance, lo not hesitate to contact me.

Very truly yours

Frederick B. Zelley

ires

Somerset County Planning Board (via regular mail, w/ encl.)

Michael Osterman, Esq. (via email and regular mail, w/ encl.)

Silver Living LLC (via email, w/o plans)

William G. Hollows, P.E. (via email, w/o plans)

Douglas Battersby, R.A. (via email, w/o plans)

DIMENSIONAL STATISTICS


	REQUIRED	EXISTING	PROPOSED
LOT AREA	0.5 ac	0.19 ac	0.19 ac
LOT WIDTH	156.25'	115.89' (E. Allen)	115.89' (E. Allen)
FRONTAGE	75'	118.2' (E. Allen)	118.2' (E. Allen)
FRONT YARD SETBACK	40'	10.3' (E. Allen) 33.2' (N. Maple)	5.9' (E. Allen) 28.0' (N. Maple)
REAR YARD SETBACK	40'	30'	23.8'
COMBINED SIDE YARD	60'	N/A (Corner Lot)	N/A (Corner Lot)
SIDE YARD	20'	40.6'	22.1'
COVERAGE	20%	19.3%	32.5%
HEIGHT	35'/2.5 stories	2.5 stories	34.75'/2.5 stories
IF REQUIRED, GROSS FLOOR AREA	Not Required		
IF REQUIRED, FLOOR AREA RATIO	Not Required		
IF REQUIRED, IMPROVABLE LOT AREA	5,000 sf	4,402 sf	4,402 sf

Proposed New Single-Family Dwelling: Silver Living LLC

14 N. Maple Ave. Township of Bernards, NJ 07920

	DR	AWING INDEX					
SHEET NO.		SHEET NAME	VARIANCE	PERMIT	REV. 1	REV. 2	REV. 3
ARCHITECTU	JRAL						
A-00	BASEMENT CONSTRUCTION PLA	N .	X				
A-01	1ST FLOOR CONSTRUCTION PI	AN	X				
A-02	2ND FLOOR CONSTRUCTION P	LAN	X				
A-03	ATTIC CONSTRUCTION PLAN		X				
A-04	EXTERIOR ELEVATIONS		X				
A-05	EXTERIOR ELEVATION		X				

BUILDING CHARACTERISTICS		
BUILDING CLASSIFICATION	SINGLE FAMILY RESIDENCE	
USE GROUP	R5	
CONSTRUCTION TYPE	5B	
NUMBER OF STORIES	2.5	
AREA OF LARGEST FLOOR	1,911 SF	ATTIC: 312 SQ. FT. (W/ CLEARANCE OF 7FT.)
NEW BUILDING AREA	4,100 SF	2ND FLOOR: 1,877 SQ. FT. 1ST FLOOR: 1,439 SQ. FT.
VOLUME OF NEW STRUCTURE	62,165 CF	GARAGE: 472 SQ. FT.
HEIGHT OF STRUCTURE	34.15 FT.	BASEMENT: 1,439 SQ. FT.
MAX. LIVE LOAD	40	

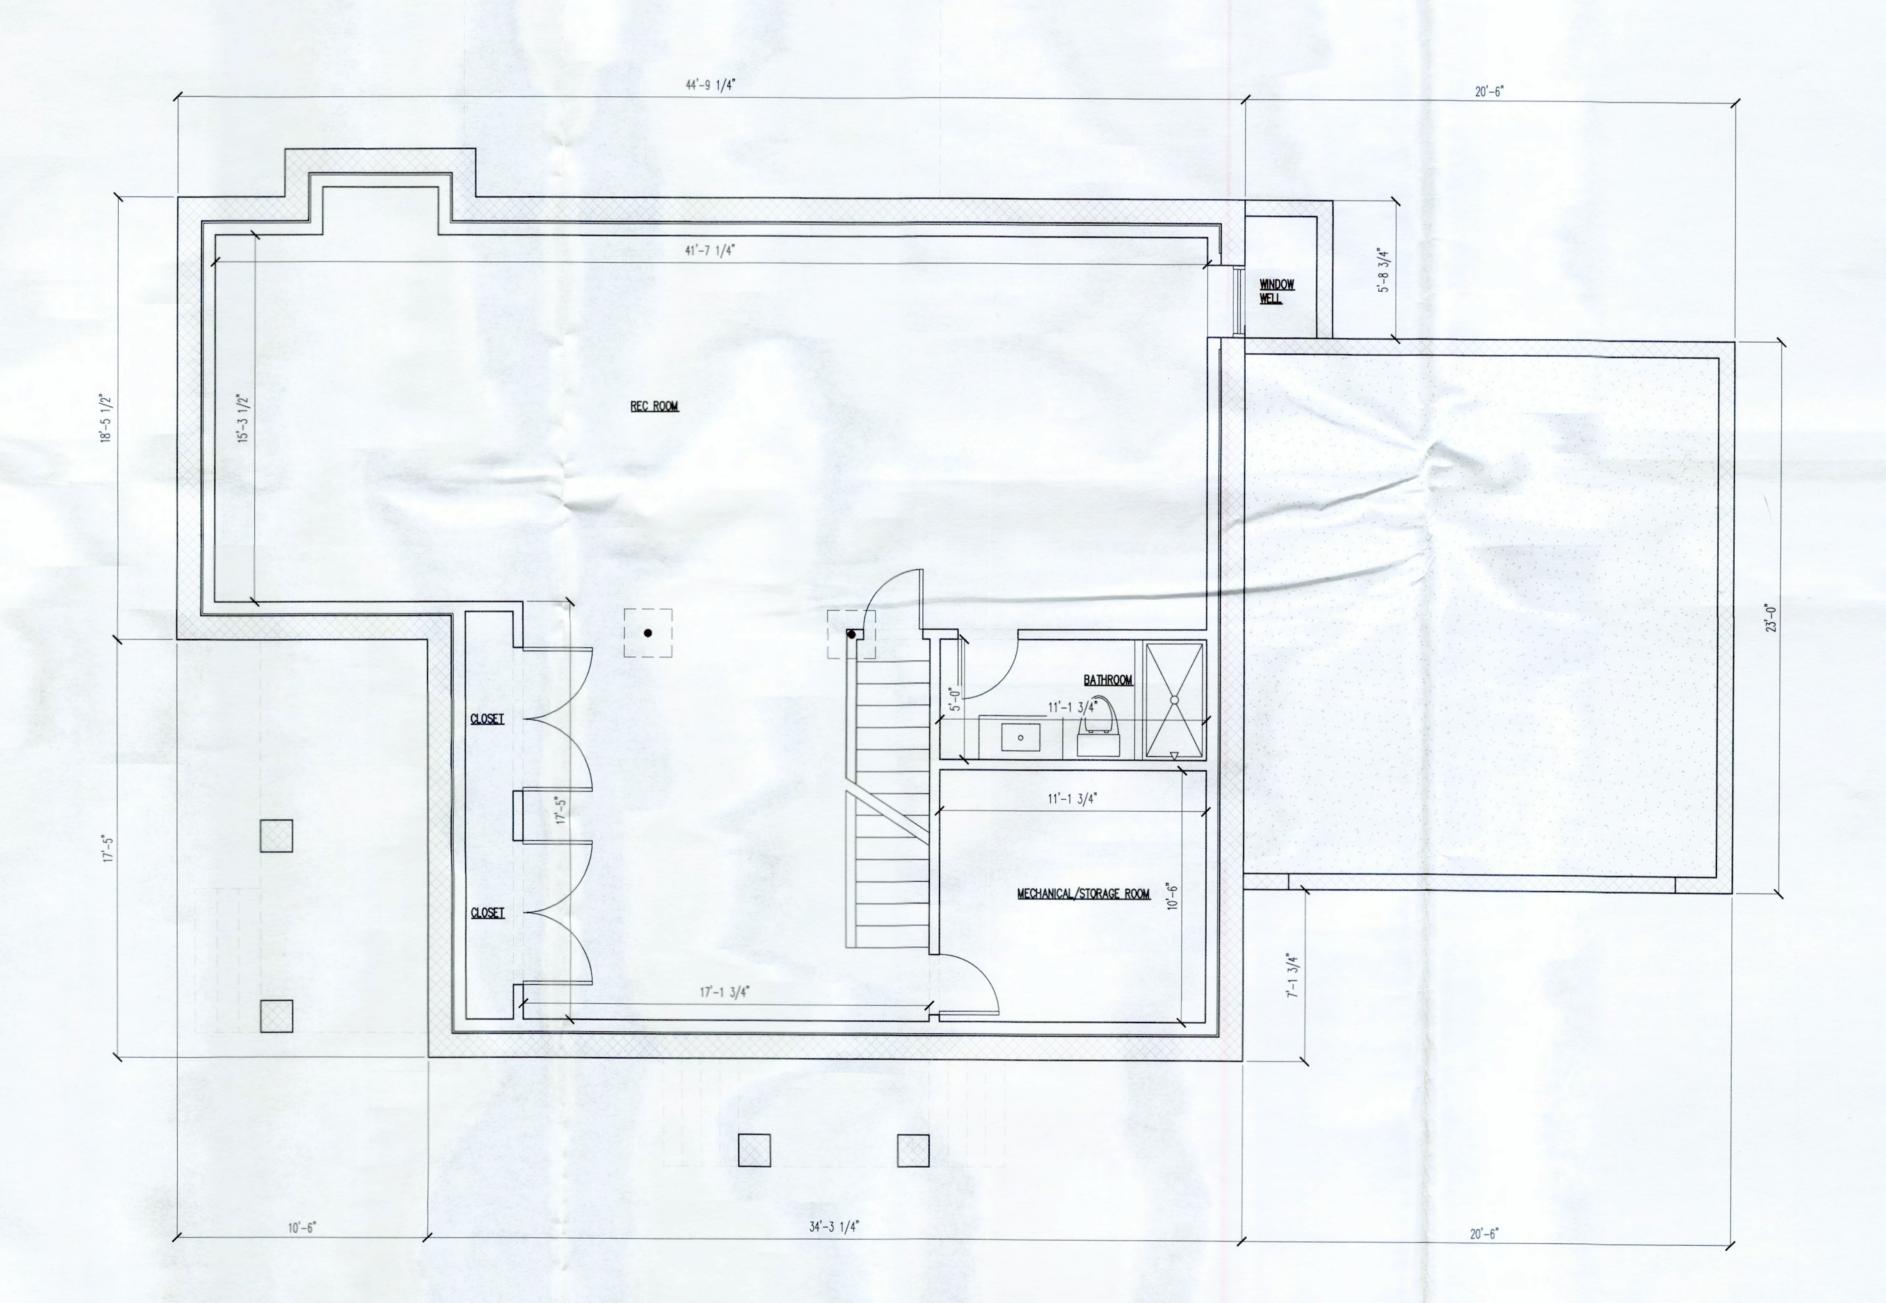

BASEMENT CONSTRUCTION PLAN

 $\int SCALE: 1/4" = 1'-0"$

HITECTURE AND DESIGN
4 RAMAPO VALLEY ROAD
P.O. BOX 370
OAKLAND, NJ 07436

PROJECT ADDRESS:

14 N. MAPLE AVE.
TOWNSHIP OF BERNARDS,
NJ 07920

ARCHITECT SEAL/SIGNATURE:

DOUGLAS G. BATTERSBY LIC #:21AI02032000

REVIEW 2/24/2020
VARIANCE 7/28/2020
VARIANCE 1/27/2021

PROJECT NAME:


14 N. MAPLE AVE.

SHEET NAM

BASEMENT CONSTRUCTION PLAN

SHEET NUMBER:

A-00

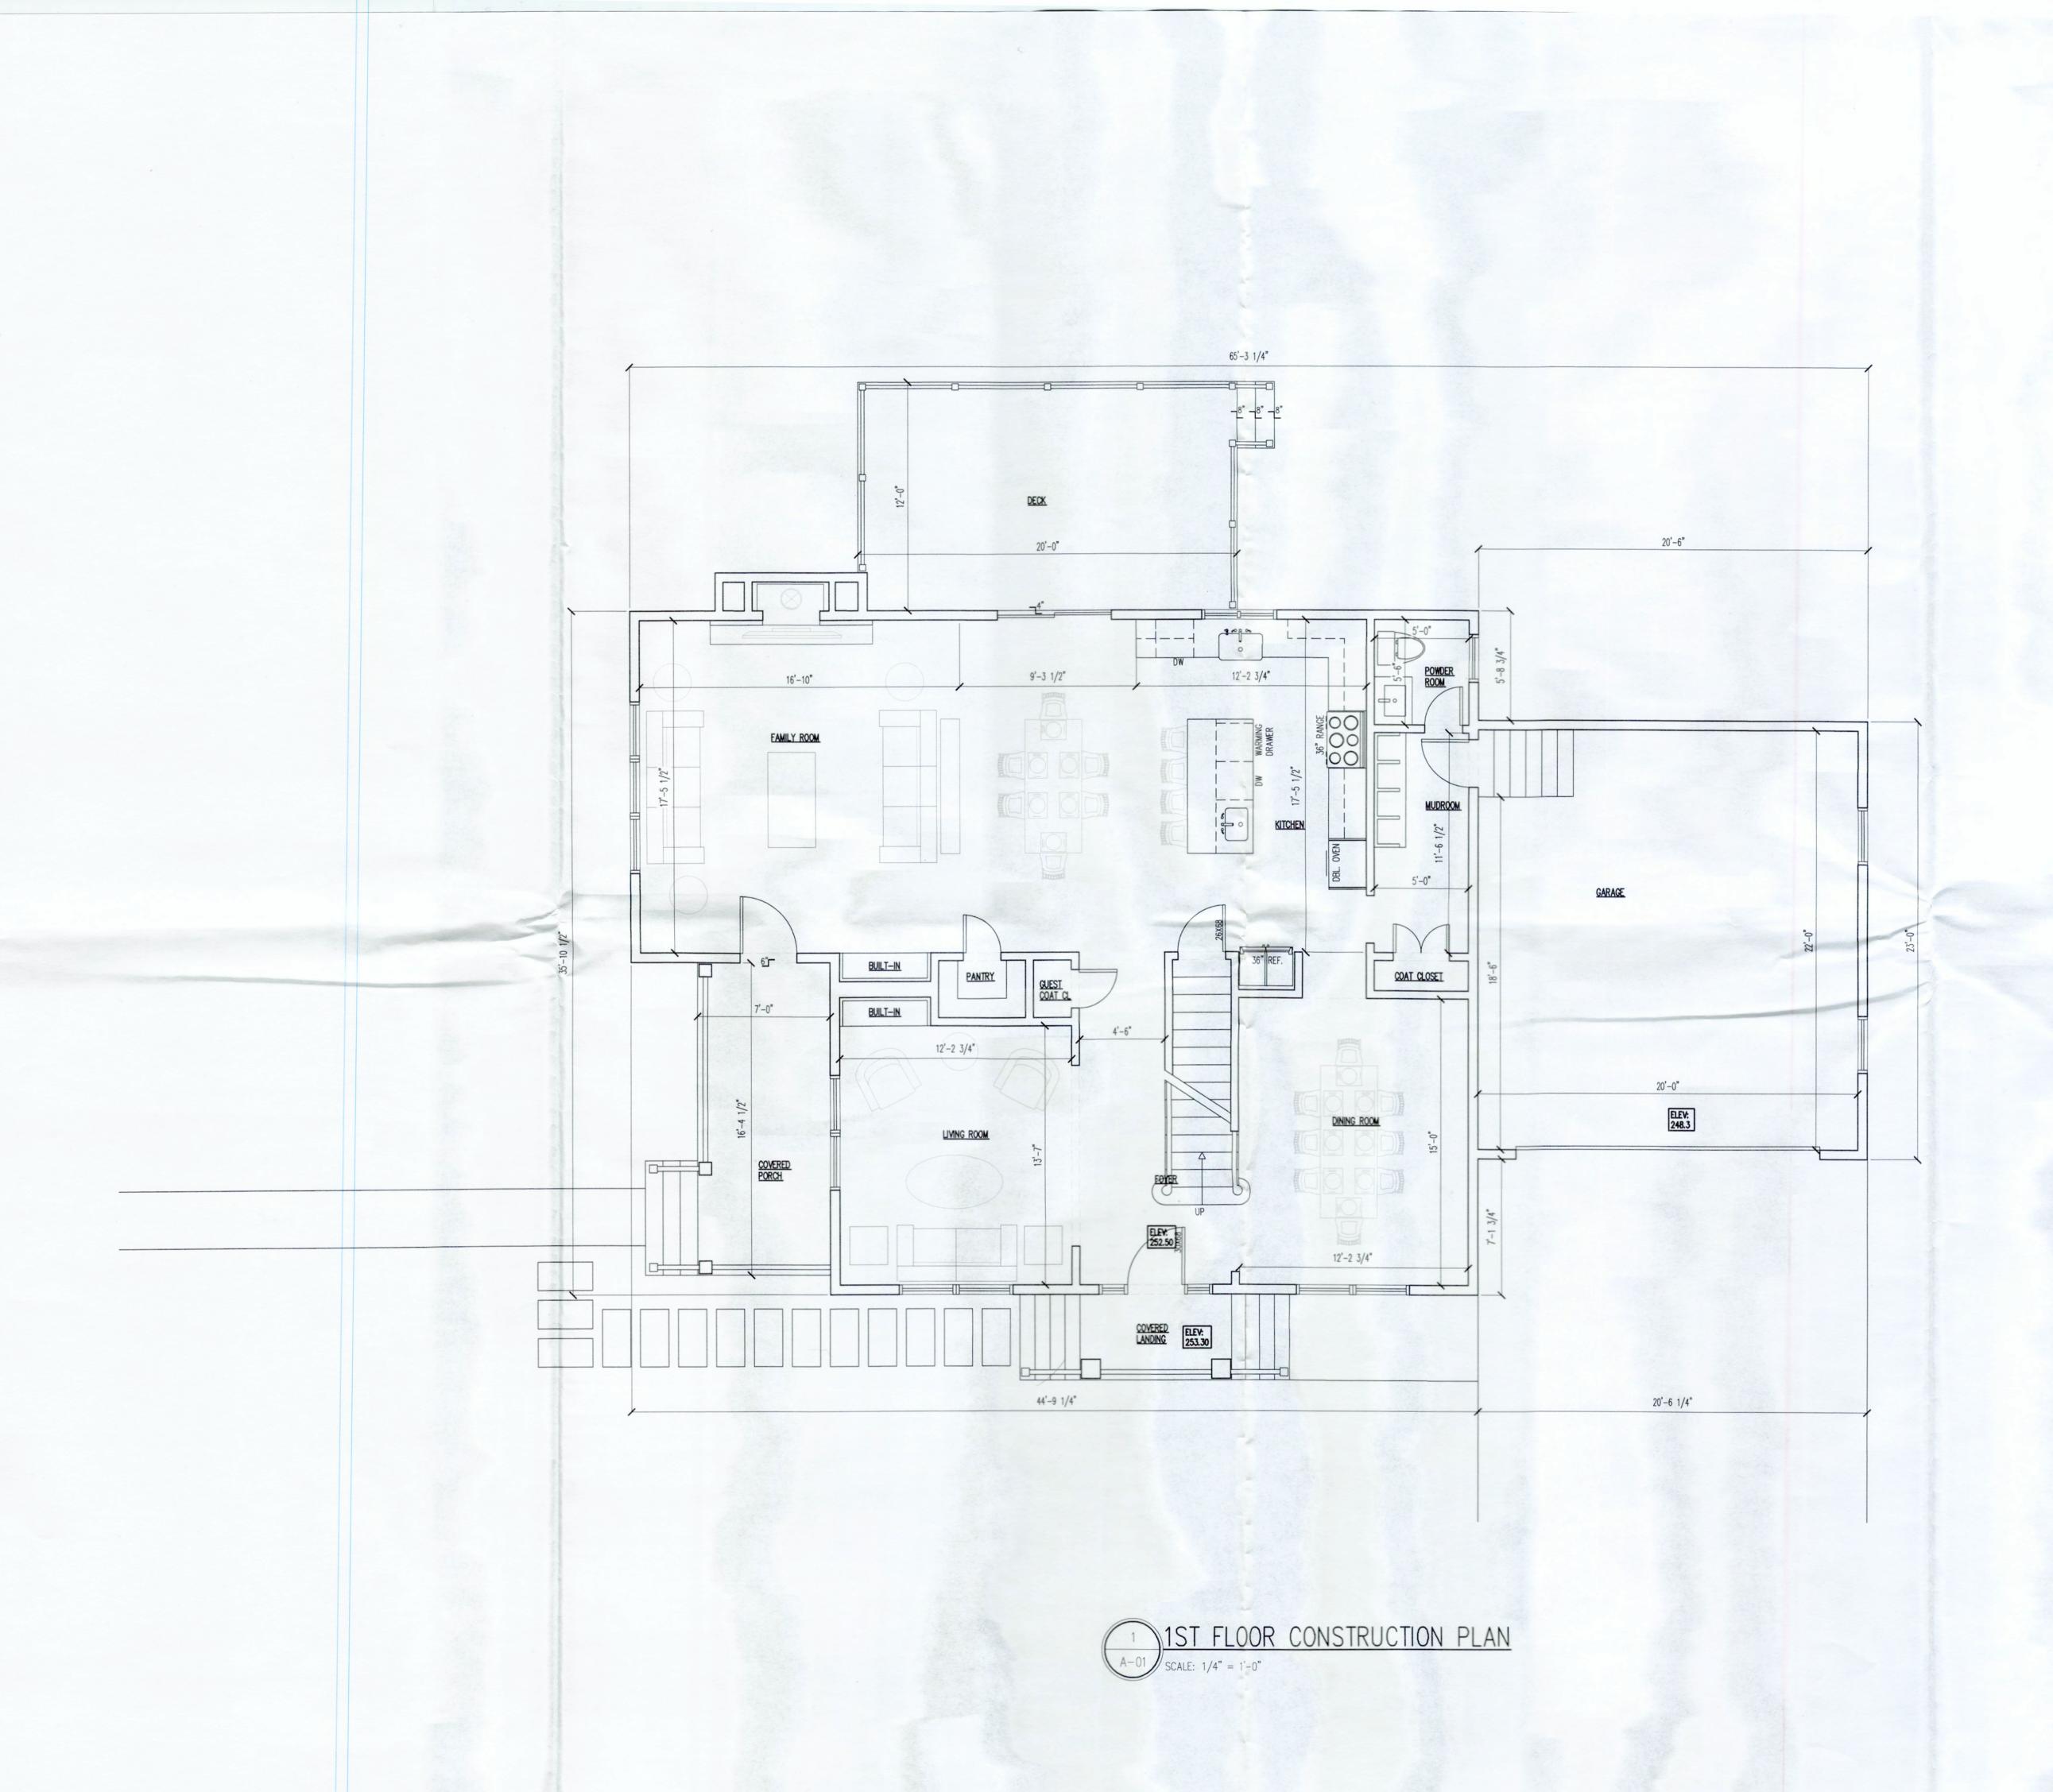

BATTERSBY ARCHITECTURE AND DESIGN

PROJECT ADDRESS:

14 N. MAPLE AVE. TOWNSHIP OF BERNARDS, NJ 07920

ARCHITECT SEAL/SIGNATURE:

DOUGLAS G. BATTERSBY LIC #:21AI02032000

13	SSUAN	ICE
	REVIEW	2/24/2020
	VARIANCE	7/28/2020
	VARIANCE	1/27/2021

PROJECT NAME:

14 N. MAPLE AVE.


PROJECT NUMBER: 009089

SHEET NA

1ST FLOOR CONSTRUCTION PLAN

SHEET NUMBER:

A-01

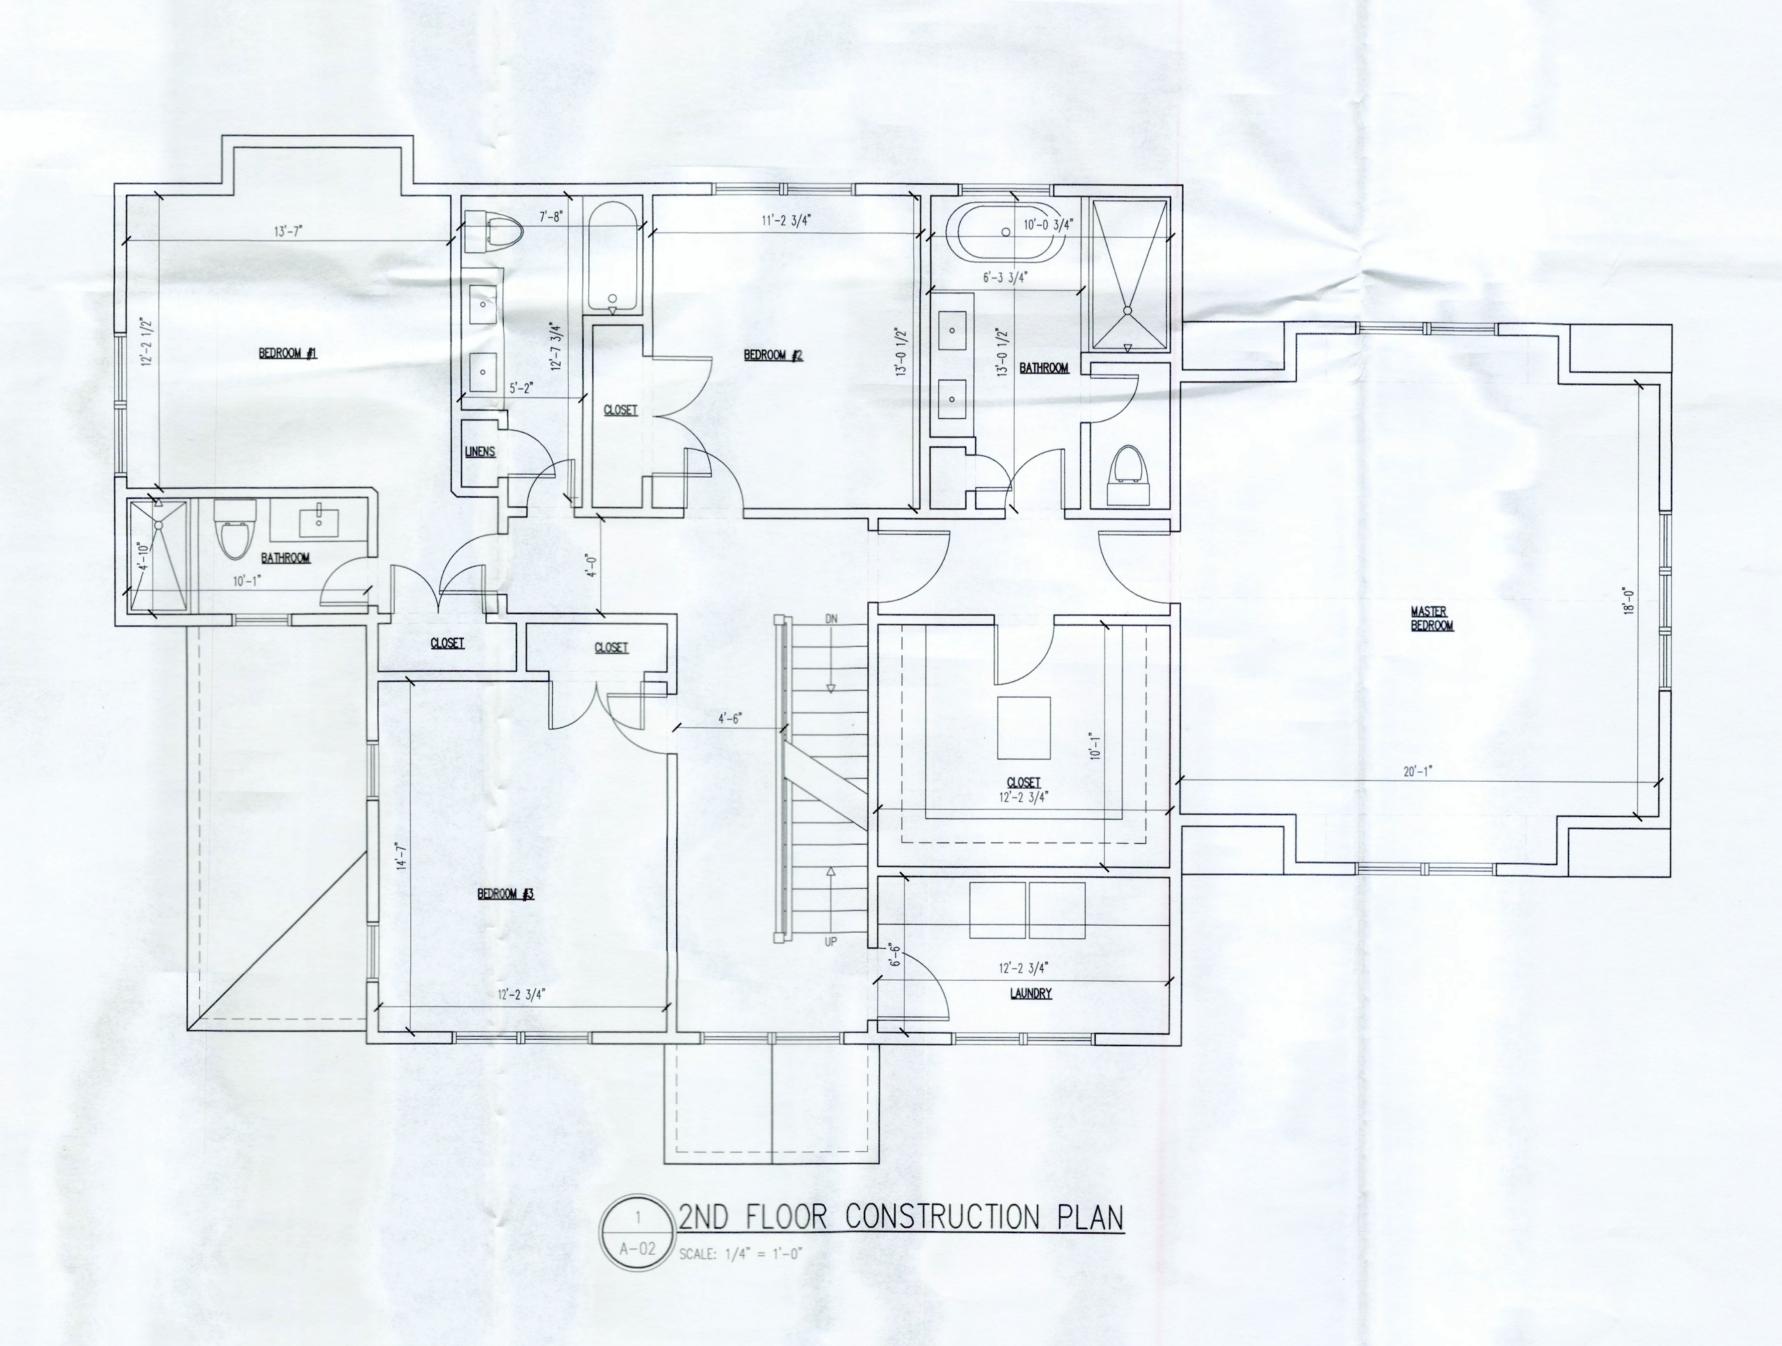

ARCHITECTURE AND DESIGN

PROJECT ADDRESS:

14 N. MAPLE AVE. TOWNSHIP OF BERNARDS, NJ 07920

ARCHITECT SEAL/SIGNATURE:

DOUGLAS G. BATTERSBY LIC #:21AI02032000

REVIEW	2/24/2020
VARIANCE	7/28/2020
VARIANCE	1/27/2021


PROJECT NAME:

14 N. MAPLE AVE.

PROJECT NUMBER: 009089

2ND FLOOR CONSTRUCTION PLAN

SHEET NUMBER:

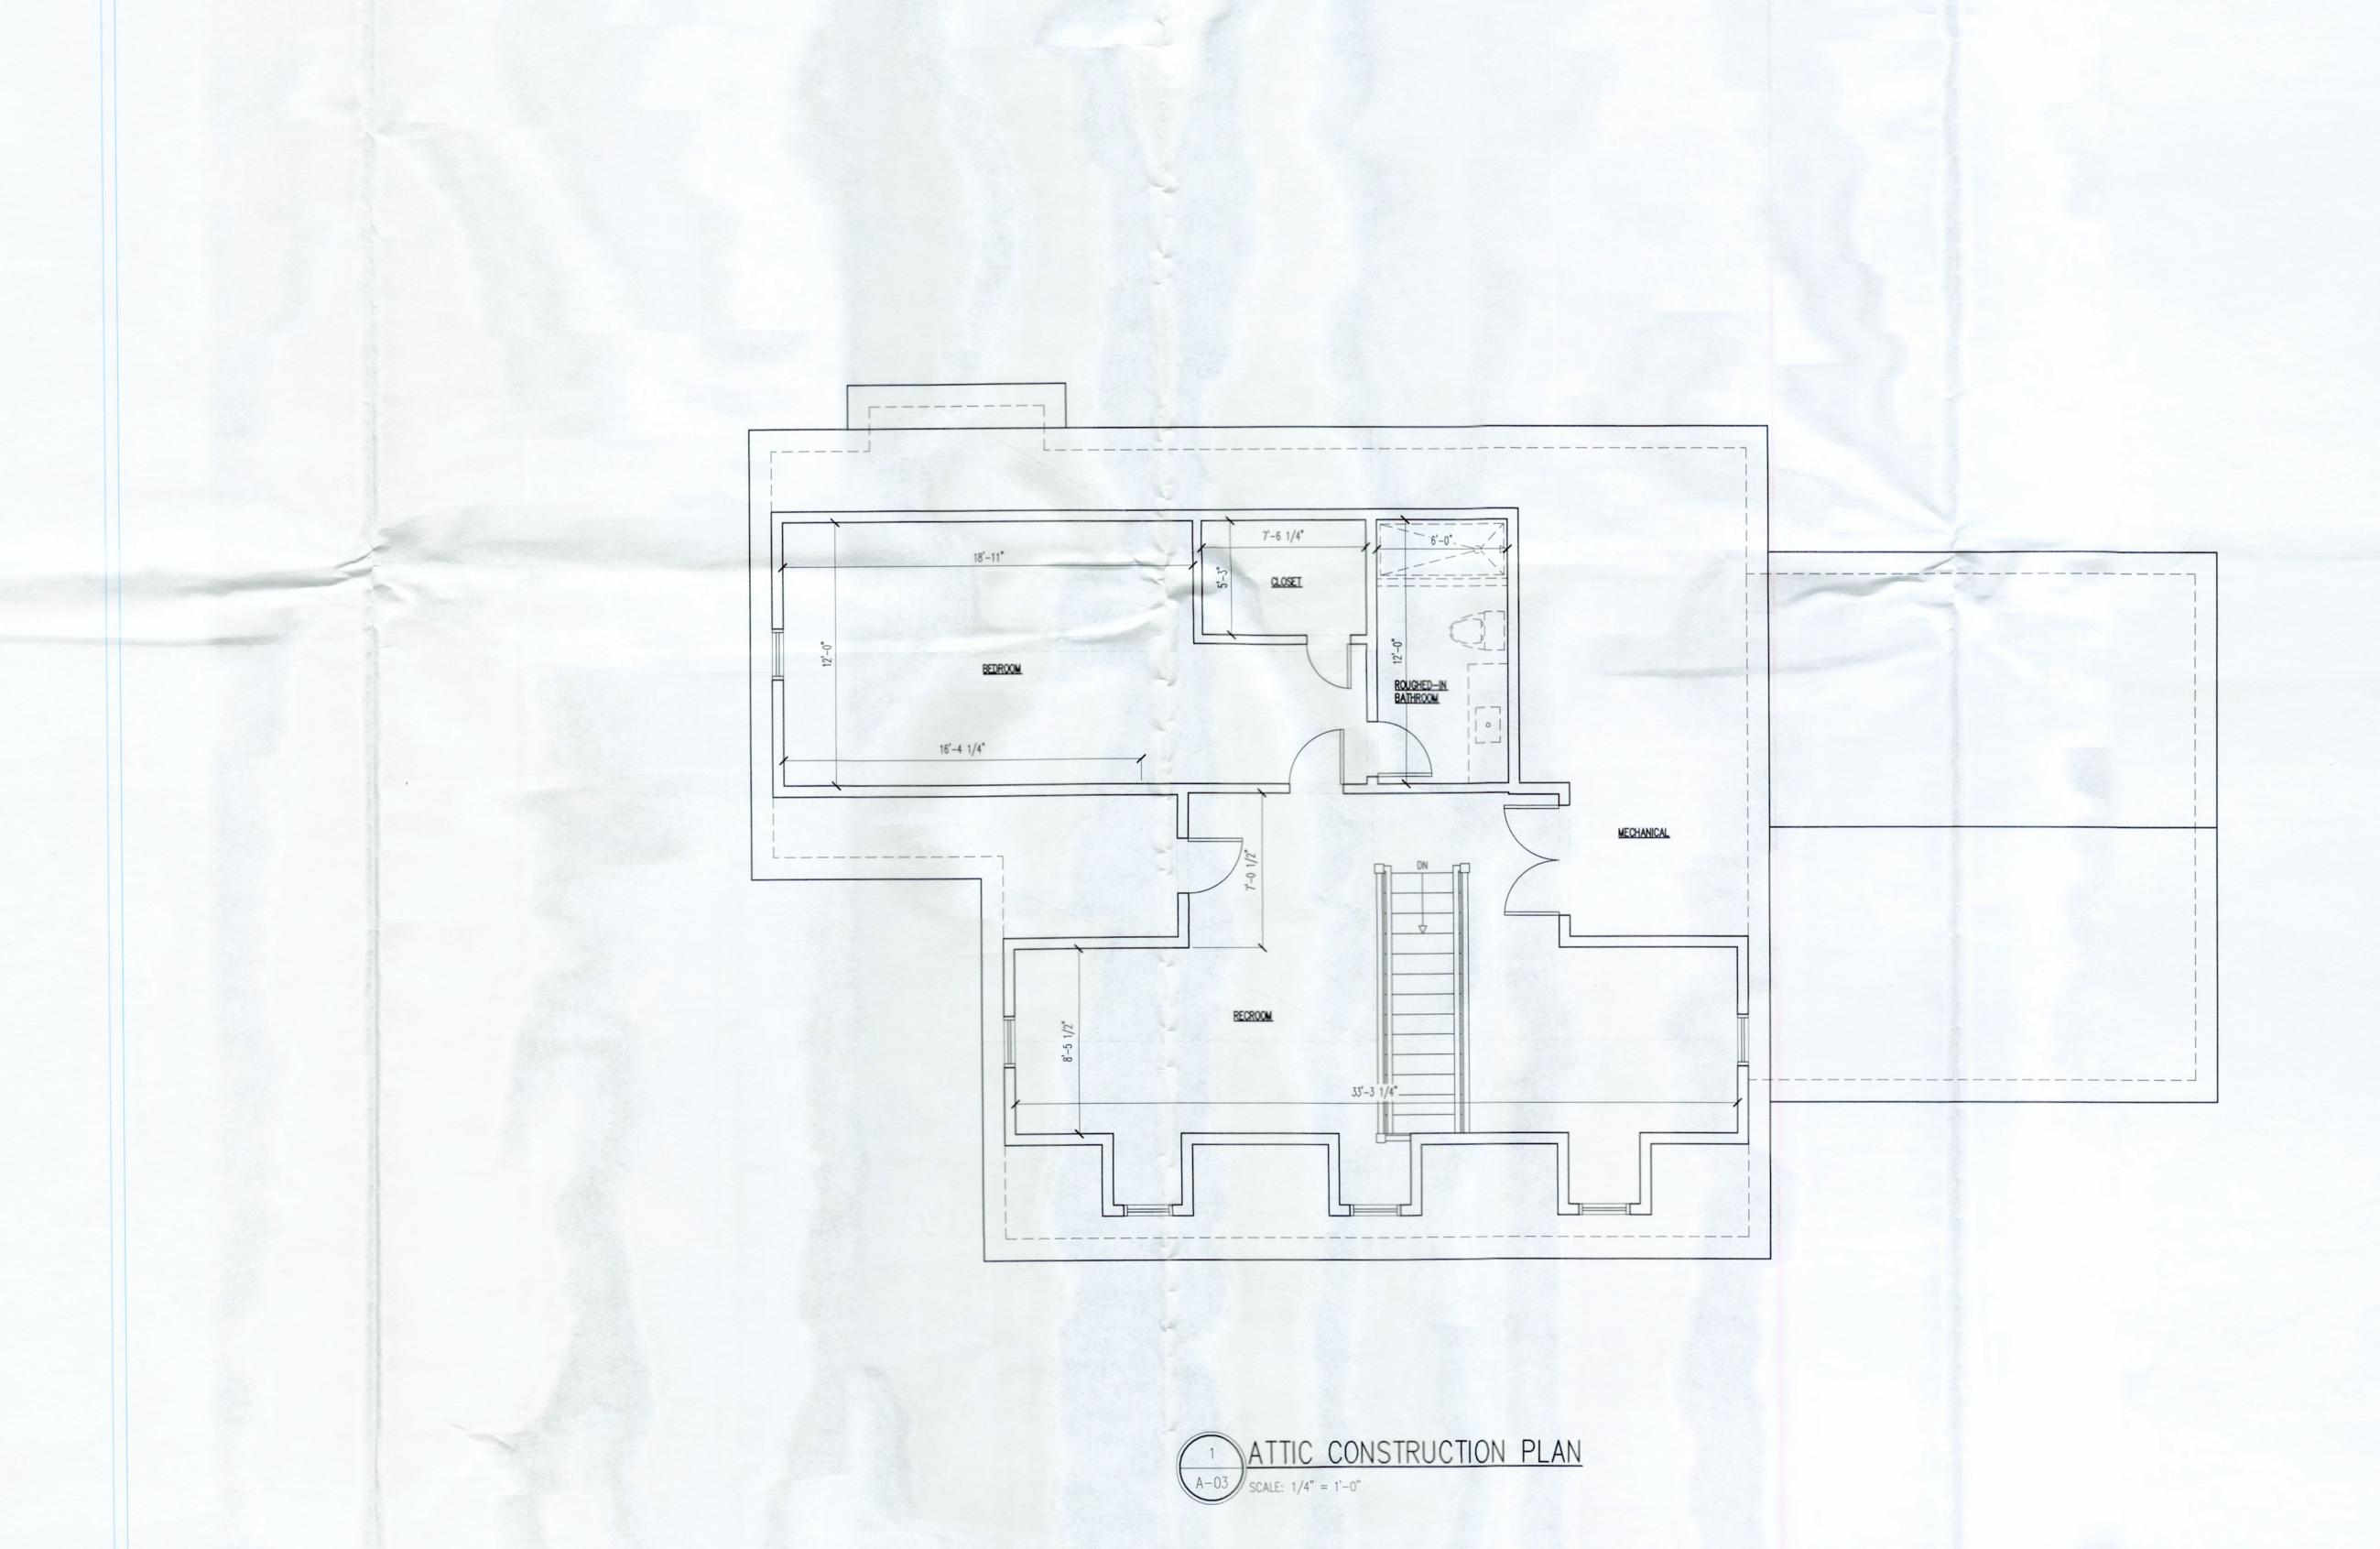

PROJECT ADDRESS:

14 N. MAPLE AVE. TOWNSHIP OF BERNARDS, NJ 07920

ARCHITECT SEAL/SIGNATURE:

DOUGLAS G. BATTERSBY LIC #:21AI02032000

ISSUANCE

ICE
2/24/2020
7/28/2020
1/27/2021

PROJECT NAME:

14 N. MAPLE AVE.

PROJECT NUMBER: 009089

SHEET NAME:

ATTIC CONSTRUCTION PLAN

SHEET NUMBER:
A-03



ARCHITECTURE AND DESIGN
4 RAMAPO VALLEY ROAD
P.O. BOX 370
OAKLAND, NJ 07436

PROJECT ADDRESS:

14 N. MAPLE AVE.
TOWNSHIP OF BERNARDS,
NJ 07920

ARCHITECT SEAL/SIGNATURE:

DOUGLAS G. BATTERSBY LIC #:21AI02032000

ISSUANCE

ISSUAN	ICE
REVIEW	2/24/202
VARIANCE	7/28/202
VARIANCE	1/27/202

PROJECT NAME:

14 N. MAPLE AVE.

PROJECT NUMBER: 009089

EET NAME:

EXTERIOR ELEVATIONS

SHEET NUMBER:

A-04

(N)RIDGE ELEV: 34.15 FT. ABOVE AVG. GRADE (N)ATTIC CLG.
ELEV: 7'-6" ABOVE ATTIC FL (N)ATTIC FLOOR
ELEV: 9'-11 1/8" ABOVE
2ND FL.
(N)2ND FLOOR CLG.
ELEV: 9'-1 1/8" ABOVE 2ND FL. TW30410 TW30410 TW30410 TW30410 (N)2ND FLOOR
ELEV: 10'-1 3/4" ABOVE
1ST FL (263.96)
(N)1ST FLOOR CLG.
ELEV: 9'-1 1/8" FWG60611 (N)1ST FLOOR
ELEV: 0'-0" (252.5)

(N)BASEMENT CLG.
ELEV: -1'-0" AVERAGE GRADE ELEV: (249.36) (N)BASEMENT FLOOR ELEV: -9'-0"

REAR ELEVATION

SCALE: 1/4" = 1'-0"

ARCHITECTURE AND DESIGN

PROJECT ADDRESS:

14 N. MAPLE AVE. TOWNSHIP OF BERNARDS, NJ 07920

ARCHITECT SEAL/SIGNATURE:

DOUGLAS G. BATTERSBY LIC #:21AI02032000

ISSLIANCE

REVIEW	2/24/2020
VARIANCE	7/28/2020
VARIANCE	1/27/2021

PROJECT NAME:

14 N. MAPLE AVE.

PROJECT NUMBER: 009089

SHEET NAME:

EXTERIOR ELEVATION

SHEET NUMBER:

A-05

ZONING SCHEDULE:

MIN. LOT AREA MIN. LOT WIDTH (CORNER)

MIN. REAR YARD
MIN. SIDE YARD (ONE)
MIN. SIDE YARD (COMBINED)
MAX. LOT COVERAGE
MAX. BUILDING HEIGHT

MIN. IMPROVABLE LOT AREA

MIN. ACCESSORY SIDE SETBACK


MIN. ACCESSORY REAR SETBACK

MIN. ACCESSORY DISTANCE BETWEEN BLDGS 10 FT

MIN. LOT FRONTAGE MIN. FRONT YARD

ZONE: R-7


REQUIREMENT

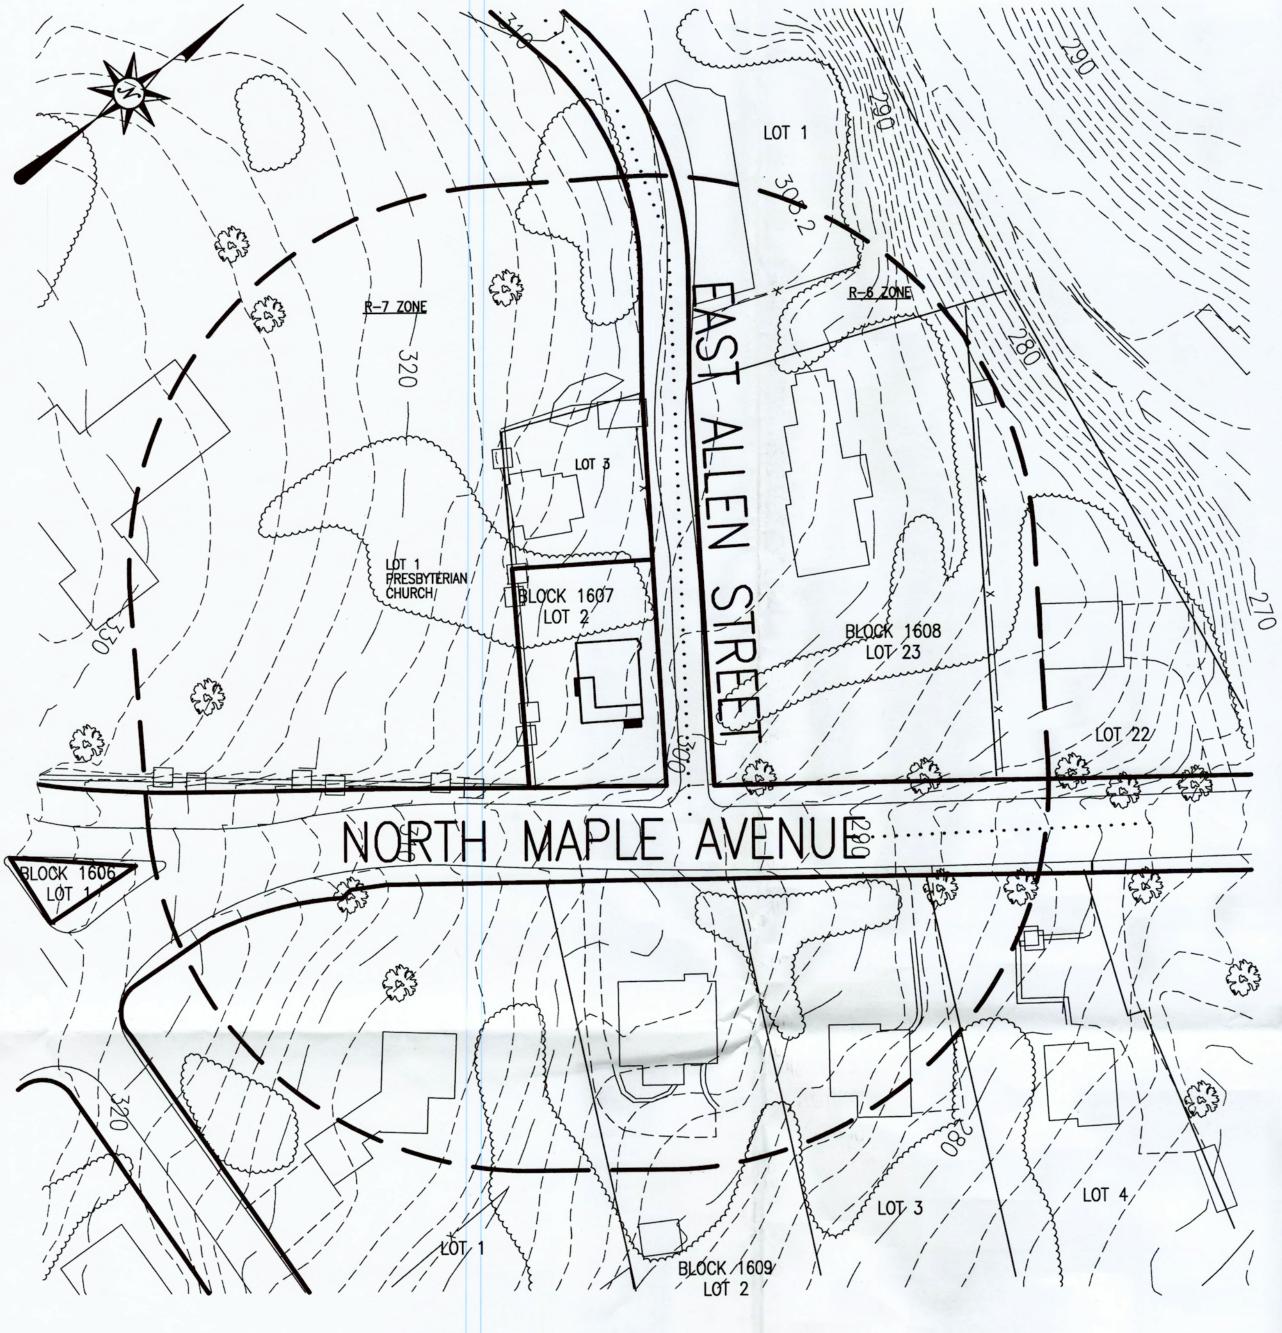

PROPERTY OWNERS WITHIN 200 FEET OF SUBJECT PROPERTY

MENDIOLA, REDENTOR JR & QUTIERREZ, E 21 N. MAPLE AVENUE, BASKING RIDGE, NJ 07920 CHARLAND, PAUL 19 N. MAPLE AVENUE, BASKING RIDGE, NJ 07920 PHILIPSCHECK, SUSAN 24 N. MAPLE AVENUE, BASKING RIDGE, NJ 07920 GRANT, KATHLEEN L. 17 E. ALLEN STREET, BASKING RIDGE, NJ 07920 BASKING RIDGE PRESBYTERIAN CHURCH 1 E. OAK STREET, BASKING RIDGE, NJ 07920 1607 1

TA	ABLE OF DRAWINGS
SHEET NO.	DESCRIPTION
1	AREA MAP/ZONING SCHEDULE
2	EXISTING/PROPOSED CONDITIONS
3	DETAILS

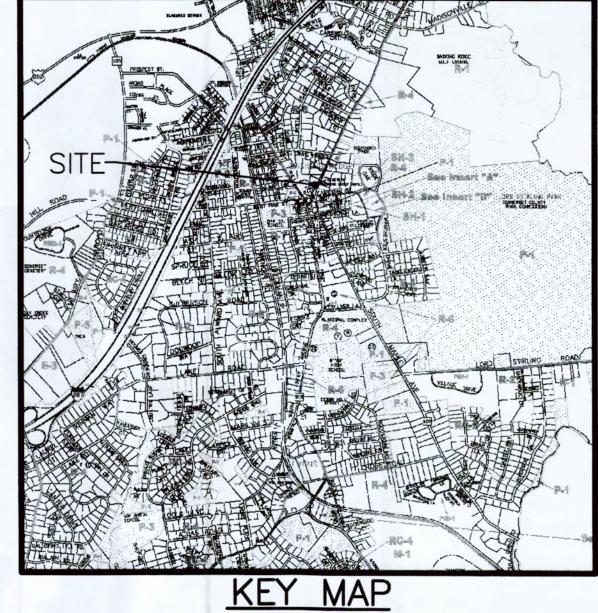

GENERAL NOTES:

- 1. SUBJECT PROPERTY KNOWN AS LOT 2, BLOCK 1607 TAX MAP SHEET No. 16.
- 2. AREA OF LOT 2, BLOCK 1607 = 8,416 SF; 0.19 Ac. TO SIDELINE
- 3. OWNER & APPLICANT:

MARCO & MICHELLE SCARABAGGIO SILVER LIVING LLC 106 WOODBINE CIRCLE NEW PROVIDENCE, NJ 07974

- 4. ATTORNEY FOR APPLICANT:
- FREDERICK B. ZELLEY, ESQ. BISOGNO, LOEFFLER & ZELLEY 88 S. FINLEY AVENUE PO BOX 408 BASKING RIDGE, NJ 07920 908.766.6666
- 4. ARCHITECT FOR APPLICANT:

DOUGLAS BATTERSBY BATTERSBY ARCHITECTURE AND DESIGN PO BOX 370

- A) BERNARDS TOWNSHIP PLANNING BOARD
- B) SOMERSET COUNTY PLANNING BOARD C) SOMERSET/UNION SOIL CONSERVATION DISTRICT
- D) BERNARDS TOWNSHIP SEWERAGE AUTHORITY

BOARD OF THE TOWNSHIP OF BERNARDS

DATE

CHAIRPERSON-BRAD BRESLIN	DATE
SECRETARY - CYNDI KIEFER	DATE

ENGINEER - THOMAS TIMKO, PE

WILLIAM G. HOLLOWS N.J. LIC. PROFESSIONAL ENGINEER & LAND SURVEYOR #27473 N.J. PROFESSIONAL PLANNER #2530

SHEET LF19-104 OF

THIS PLAN HAS BEEN APPROVED BY THE ZONING

* DENOTES EXISTING NONCONFORMING CONDITION ** DENOTES PROPOSED NONCONFORMING CONDITION

COVERAGE CALCULATIONS

985 SF 366 SF 275 SF

1626 SF

EXISTING

HOUSE PORCH WALK

TOTAL

PROPOSED

HOUSE PORCHES

WALKS DRIVE

1910 SF 180 SF

281 SF 367 SF

2738 SF

PROPOSED

118.2 FT (EAST ALLEN) 5.9 FT**(EAST ALLEN)

28.0 FT**(N. MAPLE)

23.8 FT** 22.1 FT**

34.75 FT 4402 SF*

NA

0.19 AC.* 0.19 AC.* 115.89 FT (EAST ALLEN)* 115.89 FT (EAST ALLEN)*

EXISTING

19.3%

2 1/2 STY* 4402 SF*

118.2 FT (EAST ALLEN) 10.3 FT*(EAST ALLEN) 33.2 FT*(N. MAPLE) 30.0 FT* 40.6 FT

REQUIRED

1/2 AC. 156.25 FT

75 FT

40 FT

40 FT

20 FT 60

10 FT

10 FT

35 FT/2 1/2 STY 5,000 SF

4 RAMAPO VALLEY ROAD OAKLAND, NJ 07436 OWNERS CONSENT I HEREBY CONSENT TO THE FILING OF THIS PLAN WITH THE PLANNING BOARD OF THE TOWNSHIP OF BERNARDS VARIANCE PLAN FOR AUTHORIZED SIGNATURE REQUIRED APPROVALS

DATE

CIVIL ENGINEERING AND SURVEYING 192 CENTRAL AVENUE, STIRLING, NJ 07980 908.580.1255 murphyhollows@gmail.com

SP

APRIL 27, 2020 HOUSE JANUARY 25, 2021 HOUSE

19-104

1" =50

GRAPHIC SCALE


NOVEMBER 1, 2019

CERTIFICATE OF AUTHORIZATION No. 24GA27959700

WGH

LOT 2 BLOCK 1607 14 N. MAPLE AVENUE & E. ALLEN STREET TOWNSHIP OF BERNARDS SOMERSET COUNTY **NEW JERSEY**

AIDAN T. MURPHY N.J. LIC. PROFESSIONAL ENGINEER #21319 1973-2016

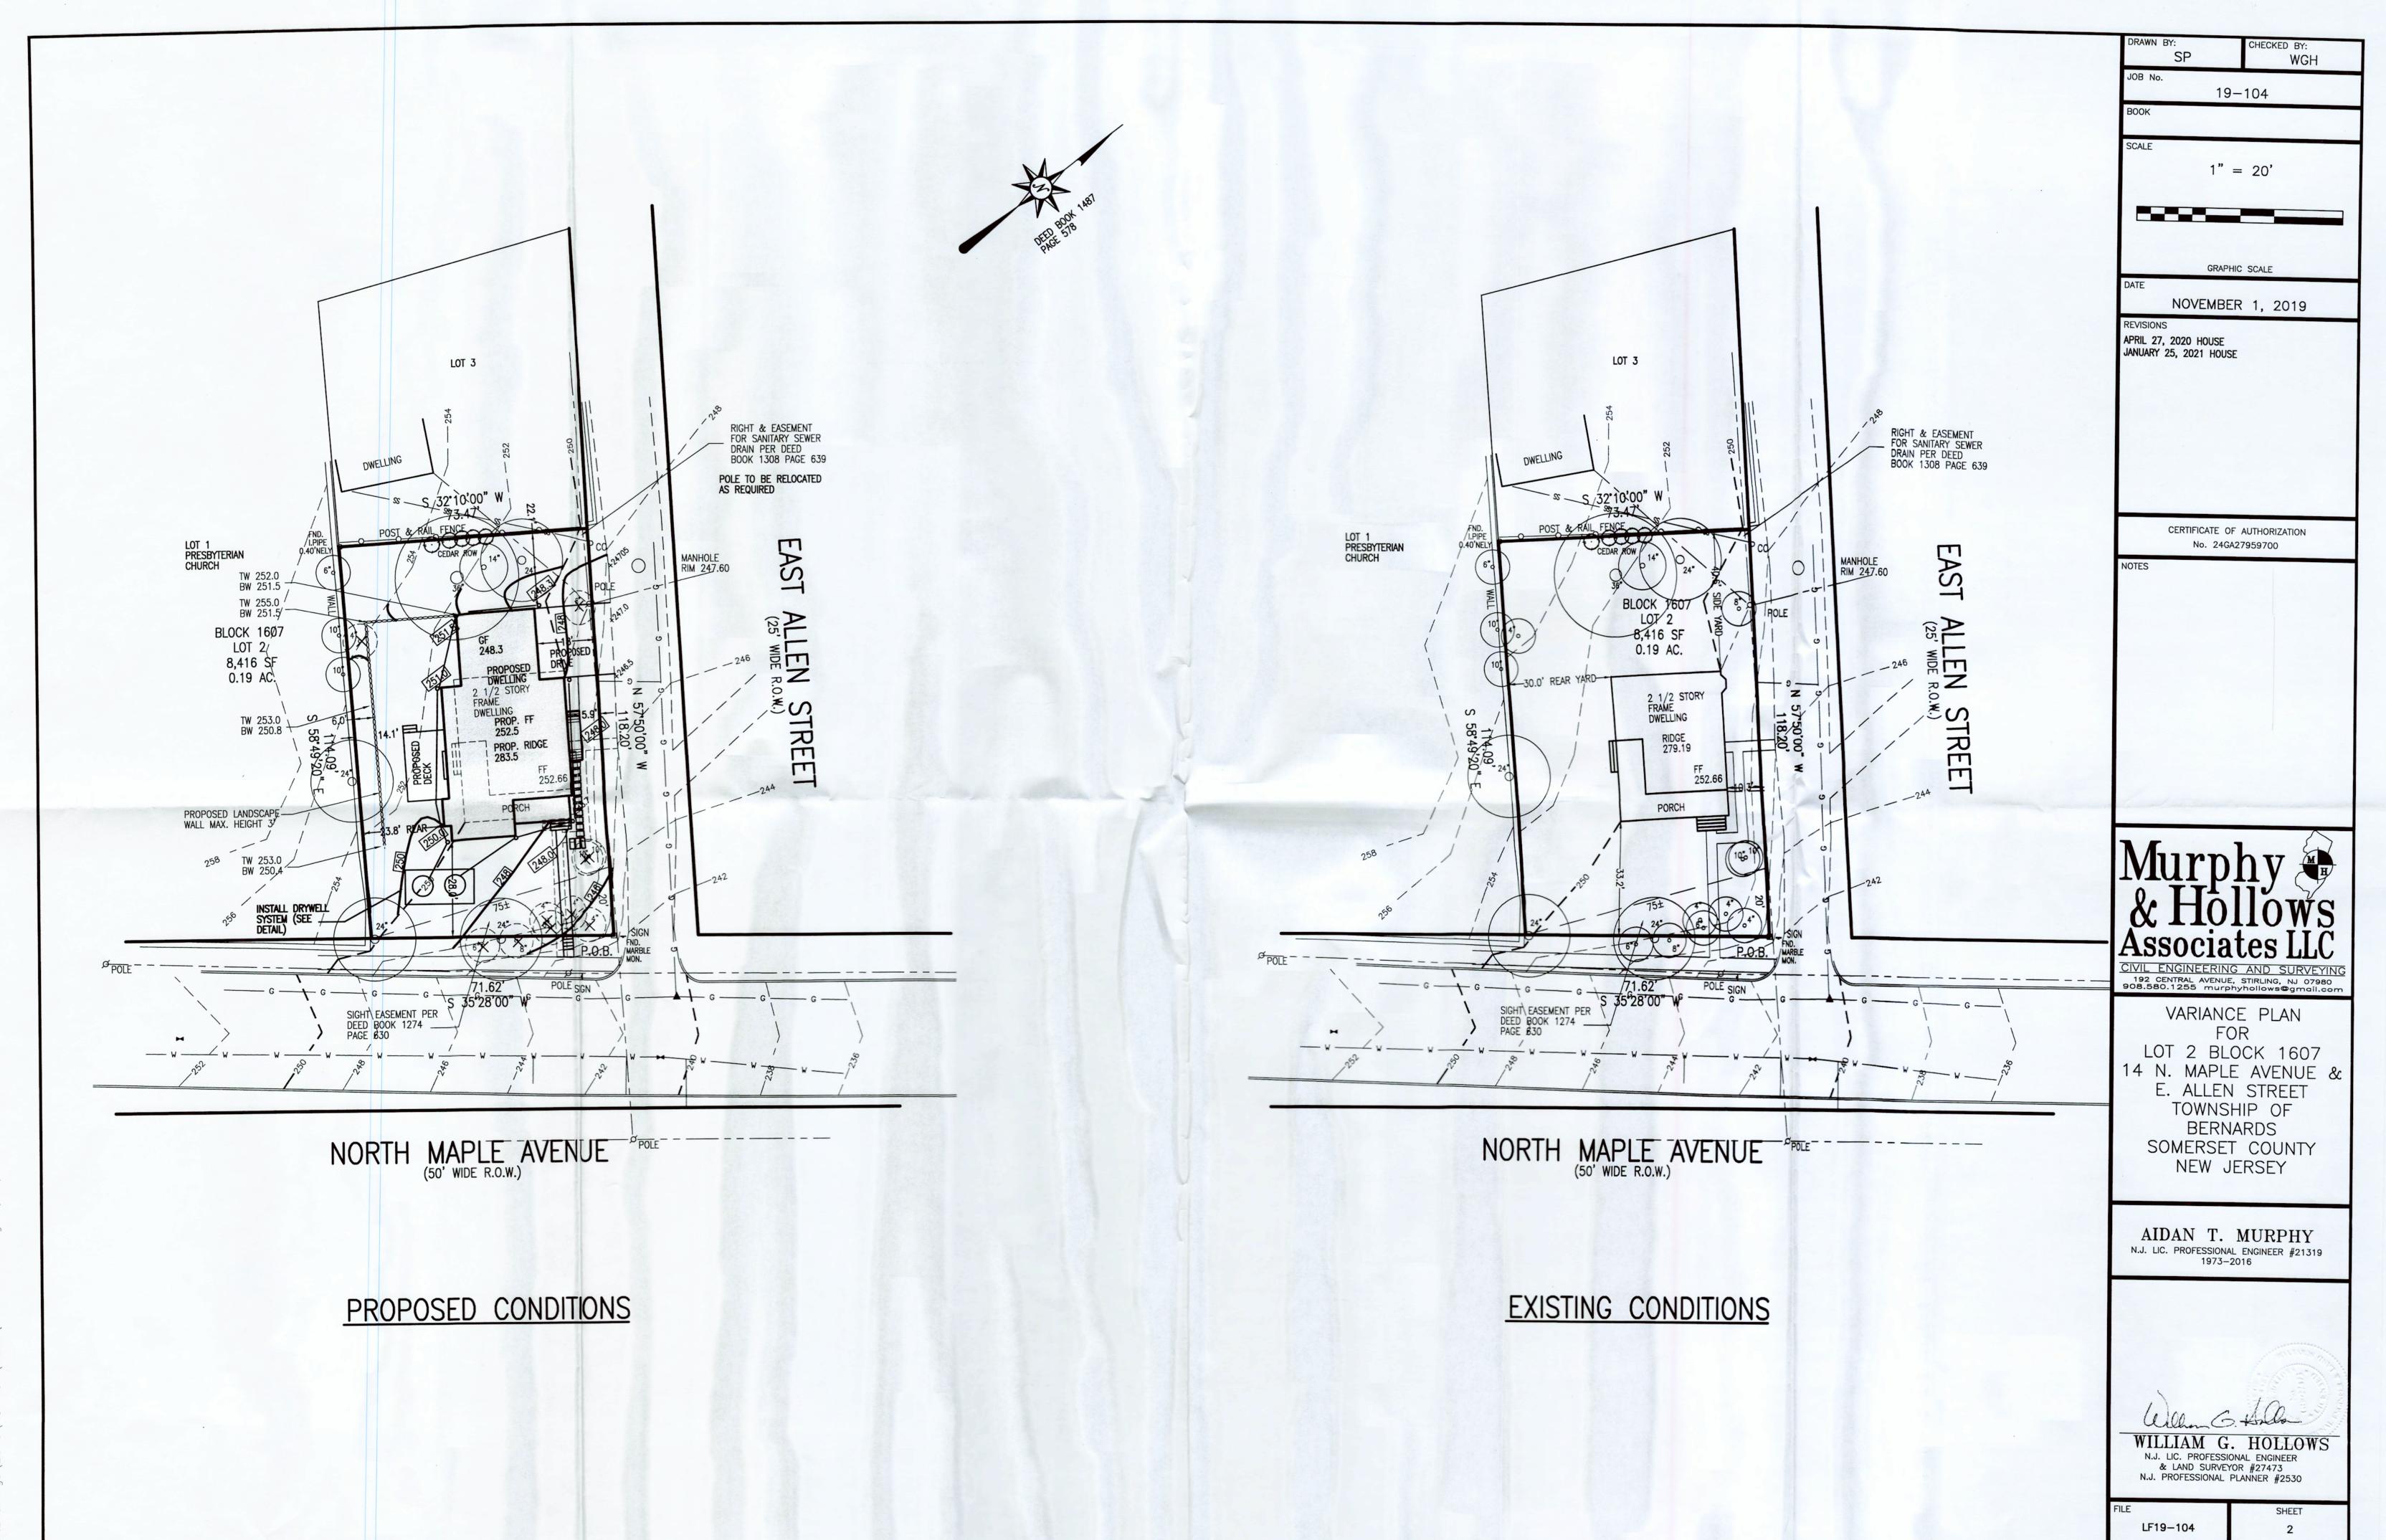

N:\CAD_Drawings\2019\19-104\REV2\19-104VP2.dwg, 1/28/2021 11:26:09 \

2. ANY DISTURBED AREA THAT WILL BE LEFT EXPOSED FOR MORE THAN THIRTY (30) DAYS AND NOT SUBJECT TO CONSTRUCTION TRAFFIC SHALL IMMEDIATELY RECEIVE A TEMPORARY SEEDING. IF THE SEASON PROHIBITS TEMPORARY SEEDING, THE DISTURBED AREAS WILL BE MULCHED WITH STRAW OR HAY AND TACKED IN ACCORDANCE WITH THE NEW JERSEY STANDARDS. SEE NOT 21 BELOW.

3. PERMANENT VEGETATION IS TO BE ESTABLISHED ON EXPOSED AREAS WITHIN TEN (10) DAYS AFTER FINAL GRADING. MULCH IS TO BE USED FOR PROTECTION UNTIL VEGETATION IS ESTABLISHED. SEE NOT 22 BELOW.

4. IMMEDIATELY FOLLOWING INITIAL DISTURBANCE OR ROUGH GRADING. ALL CRITICAL AREAS (STEEP SLOPES, SANDY SOILS, WET CONDITIONS) SUBJECT TO EROSION WILL RECEIVE A TEMPORARY SEEDING IN ACCORDANCE WITH NOTE 21 BELOW. 5. TEMPORARY DIVERSION BERMS ARE TO INSTALLED ON ALL CLEARED ROADWAYS AND EASEMENT AREAS. SEE THE DIVERSION DETAIL.

6. PERMANENT SEEDING AND STABILIZATION TO BE IN ACCORDANCE WITH THE "STANDARDS FOR PERMANENT VEGETATIVE COVER FOR SOIL STABILIZATION COVER". SPECIFIED RATES AND LOCATIONS SHALL BE ON THE APPROVED SOIL EROSION AND SEDIMENT CONTROL PLAN. 7. THE SITE SHALL AT ALL TIMES BE GRADED AND MAINTAINED SO THAT ALL STORMWATER RUNOFF IS DIVERTED TO SOIL EROSION AND SEDIMENT CONTROL FACILITIES.

8. ALL SEDIMENTATION STRUCTURES (SILT FENCE, INLET FILTERS, AND SEDIMENT BASINS) WILL BE INSPECTED AND MAINTAINED DAILY. 9. STOCKPILES SHALL NOT BE LOCATED WITHIN 50' OF A FLOODPLAIN, SLOPE, DRAINAGE FACILITY, OR ROADWAY. ALL STOCKPILES BASES

SHALL HAVE A SILT FENCE PROPERLY ENTRENCHED AT THE TOE OF SLOPE.

10. A STABILIZED CONSTRUCTION ACCESS WILL BE INSTALLED, WHENEVER AN EARTHEN ROAD INTERSECTS WITH A PAVED ROAD. SEE THE

STABILIZED CONSTRUCTION ACCESS DETAIL AND CHART FOR DIMENSIONS. 11. ALL NEW ROADWAYS WILL BE TREATED WITH SUITABLE SUBBASE UPON ESTABLISHMENT OF FINAL GRADE ELEVATIONS.

12. PAVED ROADWAYS MUST BE KEPT CLEAN AT ALL TIMES.

13. BEFORE DISCHARGE POINTS BECOME OPERATIONAL, ALL STORM DRAINAGE OUTLETS WILL BE STABILIZED AS REQUIRED. 14. ALL DEWATERING OPERATIONS MUST BE DISCHARGED DIRECTLY INTO A SEDIMENT FILTER AREA. THE FILTER SHOULD BE COMPOSED OF A

FABRIC OR APPROVED MATERIAL. SEE THE DEWATERING DETAIL. 15. ALL SEDIMENT BASINS WILL BE CLEANED WHEN THE CAPACITY HAS BEEN REDUCE BY 50°. A CLEAN OUT ELEVATION WILL BE IDENTIFIED ON THE PLAN AND A MARKER INSTALLED ON THE SITE.

16. DURING AND AFTER CONSTRUCTION, THE APPLICANT WILL BE RESPONSIBLE FOR THE MAINTENANCE AND UPKEEP OF THE DRAINAGE STRUCTURES, VEGETATION COVER, AND ANY OTHER MEASURES DEEMED APPROPRIATE BY THE TOWNSHIP/DISTRICT. SAID RESPONSIBILITY WILL END WHEN COMPLETED WORK IS APPROVED BY THE TOWNSHIP.

17. ALL TREES OUTSIDE OF THE DISTURBANCE LIMIT INDICATED ON THE SUBJECT PLAN OR THOSE TREES WITHIN THE DISTURBANCE AREA WHICH ARE DESIGNATED TO REMAIN AFTER CONSTRUCTION ARE TO BE PROTECTED WITH TREE PROTECTION DEVICES. SEE THE TREE PROTECTION DETAIL.

18. THE TOWNSHIP MAY REQUEST ADDITIONAL MEASURES TO MINIMIZE ON SITE OR OFF SITE EROSION PROBLEMS DURING CONSTRUCTION. 19. THE TOWNSHIP MUST BE NOTIFIED, IN WRITING, AT LEAST 72 HOURS PRIOR TO ANY LAND DISTURBANCE, AND A PRE CONSTRUCTION MEETING HELD.

20. CONTRACTOR TO SET UP A MEETING WITH THE INSPECTION FOR PERIODIC INSPECTIONS OF THE TEMPORARY SEDIMENT BASIN PRIOR TO AND DURING ITS CONSTRUCTION.

21. TOPSOIL STOCKPILE PROTECTION A. APPLY GROUND LIMESTONE AT A RATE OF 90 LBS PER 1000 SQ FT

B. APPLY FERTILIZER (10-20-10) AT A RATE OF 11 LBS PER 1000 SQ FT

C. APPLY PERENNIAL RYEGRASS SEED AT 1 LB PER 1000 SQ FT AND ANNUAL RYEGRASS AT 1 LB PER 1000 SQ FT

D. MULCH STOCKPILE WITH STRAW OR HAY AT A RATE OF 90 LBS PER 1000 SQ FT E. APPLY A LIQUID MULCH BINDER OR TACK TO STRAW OR HAY MULCH.

F. PROPERLY ENTRENCH A SILT FENCE AT THE BOTTOM OF THE STOCKPILE.

22. TEMPORARY STABILIZATION SPECIFICATION

A. APPLY GROUND LIMESTONE AT A RATE OF 90 LBS PER 1000 SQ FT B. APPLY FERTILIZER (10-20-10) AT A RATE OF 11 LBS PER 1000 SQ FT

C. APPLY PERENNIAL RYEGRASS SEED AT 1 LB PER 1000 SQ FT AND ANNUAL RYEGRASS AT 1 LB PER 1000 SQ FT

D. MULCH STOCKPILE WITH STRAW OR HAY AT A RATE OF 90 LBS PER 1000 SQ FT E. APPLY A LIQUID MULCH BINDER OR TACK TO STRAW OR HAY MULCH.

23. PERMANENT STABILIZATION SPECIFICATIONS

A. APPLY TOPSOIL TO A DEPTH OF 5 INCHES (UNSETTLED)


B. APPLY GROUND LIMESTONE AT A RATE OF 90 LBS PER 1000 SQ FT AND WORK FOUR INCHES INTO SOIL.


C. APPLY FERTILIZER (10-20-10) AT A RATE OF 11 LBS PER 1000 SQ FT D. APPLY HARD FESCUE SEED AT 2.7 LBS PER 1000 SQ FT AND CREEPING RED FESCUE SEED AT 0.7 LBS PER 1000 SQ FT AND


PERENNIAL RYEGRASS SEED AT 0.25 LBS PER 1000 SQ FT. MULCH STOCKPILE WITH STRAW OR HAY AT A RATE OF 90 LBS PER 1000 SQ FT.

APPLY A LIQUID MULCH BINDER OR TACK TO STRAW OR HAY MULCH.


*NOTE: 72 HOURS PRIOR TO ANY SOIL DISTURBANCE NOTICE IN WRITING, SHALL BE GIVEN TO BERNARDS TOWNSHIP ENGINEER(INSPECTIONS) & SOMERSET COUNTY SOIL CONSERVATION DISTRICT AND A PRE-CONSTRUCTION MEETING HELD.

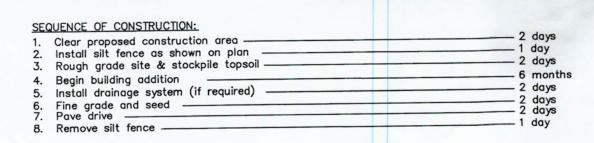

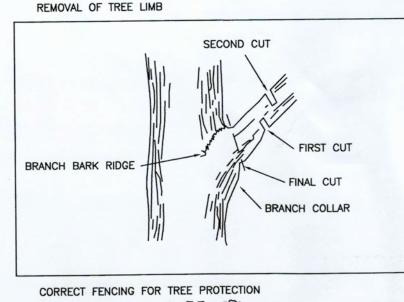


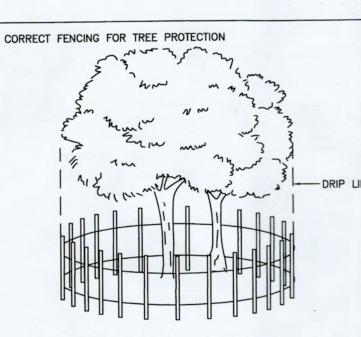


NOT TO SCALE

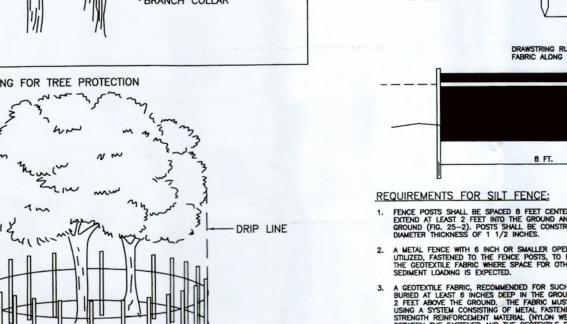




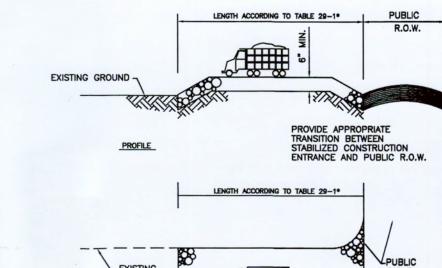

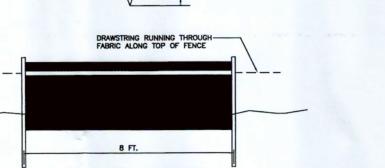


NOT TO SCALE

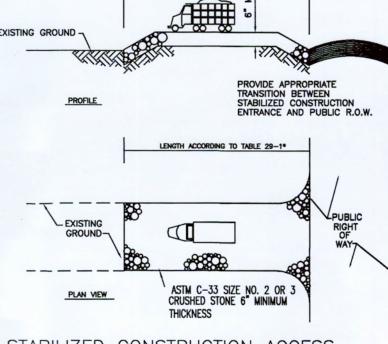


STABILIZED CONSTRUCTION ACCESS

LENGTHS OF CONSTRUCTION EXITS ON SLOPING ROADBEDS

LENGTHS OF CONSTRUCTION EXITS ON SLOPING ROADBEDS				
PERCENT SLOPE OF ROADWAY	LENGTH OF STONE REQUIRED			
PERCENT SLOPE OF ROADWAT	COARSE GRAINED SOILS	FINE GRAINED SOILS		
0-2%	50 FT.	100 FT.		
2-5%	100 FT.	200 FT.		
>5%	ENTIRE SURFACE STABILIZED	WITH FABC BASE COURSE		

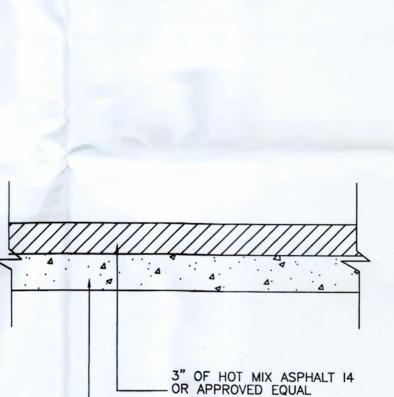

---- 4" DENSE GRADED AGGREGATE DRIVEWAY PAVEMENT DETAIL

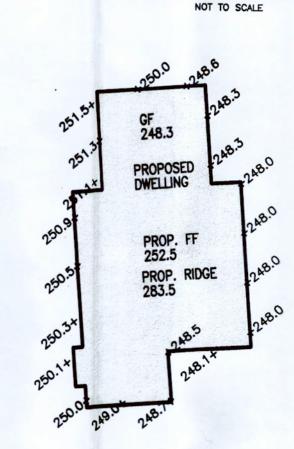

TOTAL 4987.2.7/20 = 249.36

+35.0 284.36 ALLOWABLE RIDGE HEIGHT PROPOSED RIDGE HEIGHT = 252.5 + 31.0 = 283.5 F.F. TO RIDGE = 31.0

THEREFORE BUILDING HEIGHT = 283.5-249.36 = 34.15 FT

AIDAN T. MURPHY N.J. LIC. PROFESSIONAL ENGINEER #21319 1973-2016

CIVIL ENGINEERING AND

192 CENTRAL AVENUE, STIRLING, NJ 07980 908.580.1255 murphyhollows@gmail.com

VARIANCE PLAN

FOR

LOT 2 BLOCK 1607

14 N. MAPLE AVENUE &

E. ALLEN STREET

TOWNSHIP OF

BERNARDS

SOMERSET COUNTY

NEW JERSEY

HECKED BY:

19-104

1" = 20'

GRAPHIC SCALE

NOVEMBER 1, 2019

CERTIFICATE OF AUTHORIZATION

No. 24GA27959700

WGH

SP


APRIL 27, 2020 HOUSE

JANUARY 25, 2021 HOUSE

SCALE

WILLIAM G. HOLLOWS N.J. LIC. PROFESSIONAL ENGINEER & LAND SURVEYOR #27473 N.J. PROFESSIONAL PLANNER #2530

SHEET LF19-104

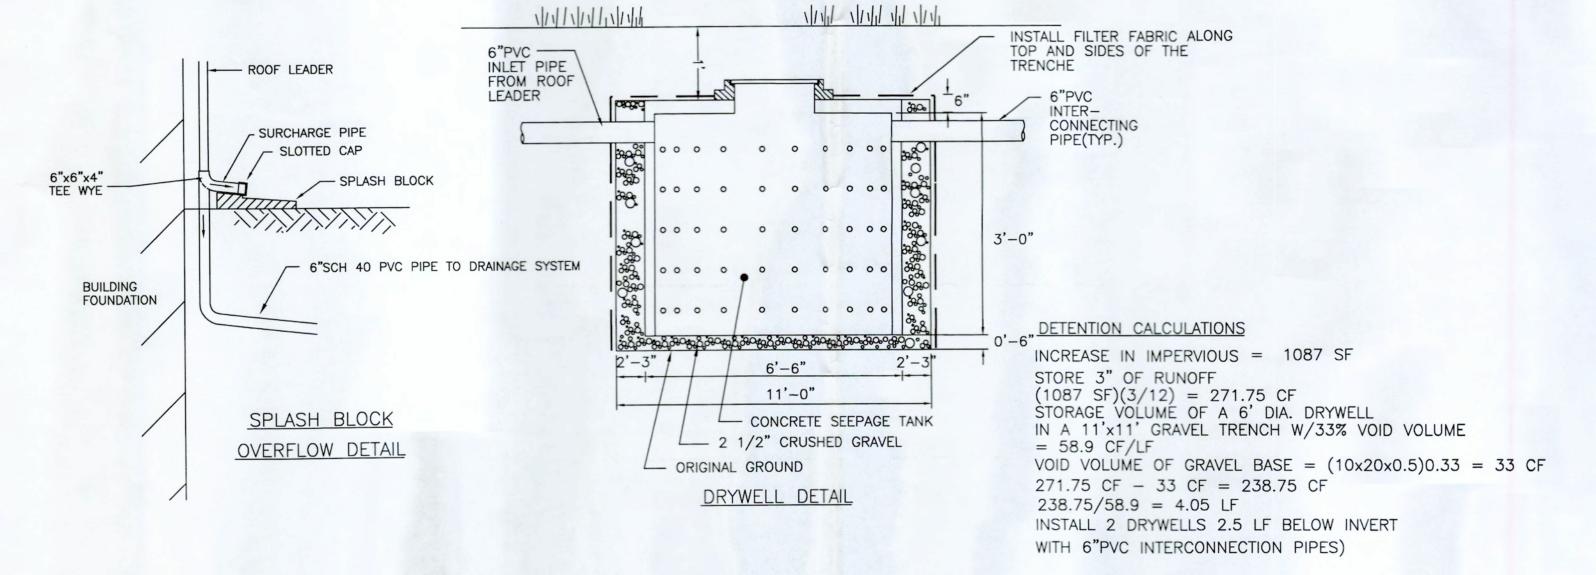

NOTE: THE PROPOSED DRAINAGE IS DEPENDENT UPON THE PERCOLATION RATE OF THE EXISTING SOIL AND WATER TABLE. THE APPLICANT SHALL COMPLETE AN ANALYSIS OF THE SOIL PRIOR TO THE INSTALLATION OF THE SEEPAGE PIT. A COPY OF THE RESULTS SHALL BE FORWARDED TO THE TOWNSHIP ENGINEER'S OFFICE. SHOULD THE EXISTING SOIL BE UNSUITABLE. AN ALTERNATE METHOD SHALL BE DESIGNED AND SUBMITTED TO THE TOWNSHIP ENGINEER'S OFFICE FOR REVIEW AND APPROVAL



TOWNSHIP OF BERNARDS ZONING BOARD OF ADJUSTMENT APPLICATION STATUS FORM

Application No: <u>ZB21 002</u> Block: <u>11102</u> Lot: Zone: <u>P-3</u>						
Applicant: ROTI, JOSEPH S. & LON SCERBO-ROTI						
Address of Property: 10 PACER COURT						
Description:	(c) FOR L' FEN	ICE IN FRONT	YARD			
	(C) FOR SLIED IN FRONT YARD					
APPLICATION CHECKLIST						
W-9 Site Own 200' Tax Own Votice Own Votice Own Ow	✓ Original + 16 copies of Application ✓ Engineering Plan/Plot Plan ✓ Site Visit Consent (A) ✓ Survey ✓ Ownership Form (B) ✓ Photographs ✓ 200' Property Search List (C) ✓ Wetlands Report/LOI ✓ Tax Certification (D) ✓ Application Fee ✓ Dimensional Statistics Form (F) ✓ Imaging Fee ✓ Contributions Disclosure Form (G) — Tax Map Revision Fee ✓ Checklist					
1.7.21	SCHEDULING Original Submission Date (10) Completeness Deadline (45 days) Incomplete Date	Notice to Date of P	Property Owners Publication Peness Hearing			
5:7:21	Resubmission Date Date Complete Time to Act (45/95/120 days)	Resolution				
1:7:21	DISTRIBUTION Environmental Comm Fire Official LCFAS	NO	TES			

TOWNSHIP OF BERNARDS 2021 ZONING BOARD OF ADJUSTMENT APPLICATION

[] Bulk or Dimensional ("c") Variance [] Use ("d") Variance [] Conditional Use ("d") Variance [] Floor Area Ratio, Density, or Height ("d") Variance [] Site Plan - Preliminary / Final [] Other (specify):
1. APPLICANT: Joseph S. Roti/Lori Scerbo Roti
Address: 10 PACER Ct.
Phone: (home) 908 647 1029 (work) (mobile) 201 921 2818
Email (will be used for official notifications): joe SAL 100 @ YAhoo, com
2. OWNER (if different from applicant): N/A
Address:
Phone: Email (will be used for official notifications):
3. ATTORNEY: U/A
Address:
Phone: Email (will be used for official notifications):
4. OTHER PROFESSIONALS (Engineer, Architect, etc. Attach additional sheet if necessary):
Name: Profession:
Address:
Phone: Email (will be used for official notifications):
5. PROPERTY INFORMATION: Block(s): ///0Z Lot(s): / Zone: R3
Street Address: 10 Pacer U. Total Area (square feet/acres):
6. ARE THERE ANY PENDING OR PRIOR PLANNING BOARD OR BOARD OF ADJUSTMENT APPLICATIONS INVOLVING THE PROPERTY? [X] No [] Yes (if yes, explain or attach Board resolution)
7. ARE THERE CURRENTLY ANY VIOLATIONS OF THE ZONING ORDINANCE INVOLVING THE PROPERTY? [] No [X] Yes (if yes, explain) I have a six ft. fence Surloyabling my poot. This Area Gaces Rickey Lane typherfore deemed a front yard.

8. ARE THERE ANY DEED RESTRICTIONS OR EASEMENTS AFFECTING THE PROPERTY? [X] No [] Yes (if yes, explain)
9. DESCRIPTION OF THE EXISTING PROPERTY AND THE PROPOSAL REQUEST: SINGLE CAMILY home. My GAMILY RESIDES IN This home. I DIAN TO Add A Stockage shed on my DROPERTY. IZX 18 m SIZE.
10. DESCRIPTION OF REQUESTED VARIANCES OR EXCEPTIONS (include Ordinance section no.): I seek A UARDANCE to locate this shed on a postion of my PRODERLY defined AS A FRONT YARD, 21-16./ I have A Six Ft. Dence supporting my pool also in the front yard 11. THE FOLLOWING ARGUMENTS ARE MADE IN SUPPORT OF THE APPLICATION: The unusual shape of my property has the majority of open space in the April Acting Rickey Lanc (fronty ard) Given the large population of deer that Prequents my propert I need A higher fence. 12. NOTARIZED SIGNATURES (ALL APPLICANTS AND OWNERS MUST SIGN):
APPLICANT(S) SIGN HERE: I/we,
Notary MANJUSREE R. REVURI NOTARY PUBLIC OF NEW JERSEY ID # 50001769 My Commission Expires 8/13/2024
OWNER(S) SIGN HERE (<u>IF APPLICANT IS NOT THE OWNER</u>):
If the application is made by a person or entity other than the property owner, or by less than all of the property owners, then the property owner or the additional owners must complete the following:
I/we, the owner(s) of the property described in this application,
hereby authorize to act as my/our agent for purposes of making and prosecuting this application and I/we hereby consent to the variance relief (if any) granted and all conditions of approval thereof.
Signature of owner(s):
Sworn and subscribed before me, this day of, 20
Notary

TOWNSHIP OF BERNARDS PLANNING BOARD / BOARD OF ADJUSTMENT

SITE INSPECTION CONSENT FORM

Applicant: Joe + Loei Roti
Block: 11102 Lot: 1
Street Address: 10 PACER Cf.
I, Joe Rote , owner of the above property, hereby acknowledge that, upon determination of completeness of the application, a site inspection may be scheduled with the Board for a mutually convenient date and time. I hereby authorize members of the Planning Board/Board of Adjustment and their representatives and consultants to enter onto the property at the time of the site inspection for the purpose of evaluating the application.
Signature: Just S. Bh' Date: 1/4/2021

DIMENSIONAL STATISTICS

	REQUIRED	EXISTING	PROPOSED
LOT AREA	ZACRES	4.267 ACRES	4.21.07 ACRAS
LOT WIDTH	250'	360'	366 370 Rickey
FRONTAGE	125'	370' RICKEY 639' PACER	370' Rickey 639' PACER
FRONT YARD SETBACK	N/A	105'	140'
REAR YARD SETBACK	20'	78'	232'
COMBINED SIDE YARD	N/A	N/A	N/A
SIDE YARD	N/A	NA	70'
COVERAGE	15%	6.0%	6-1%
HEIGHT	20	NIA	10'
IF REQUIRED, GROSS FLOOR AREA	N/A	N/A	W/A
IF REQUIRED, FLOOR AREA RATIO	N/A	NA	NA
IF REQUIRED, IMPROVABLE LOT AREA	N/A	NIA	NA

Images



12/1/2020


Yahoo Mail - Your Custom Shed Design Has Been Submitted For A Quote (#1606156708416664-1 - Joe Roti)

Images




Front

Right

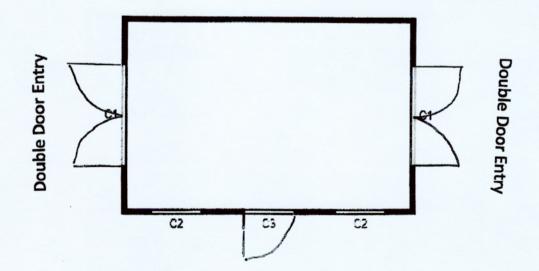






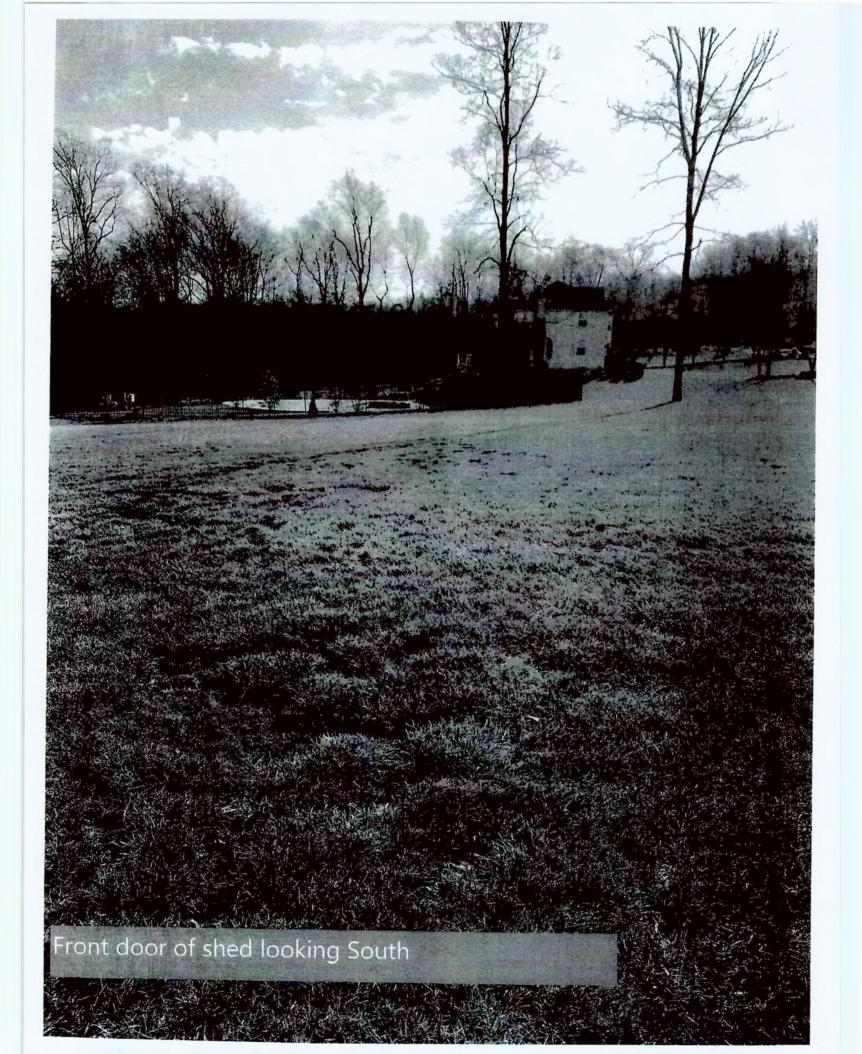



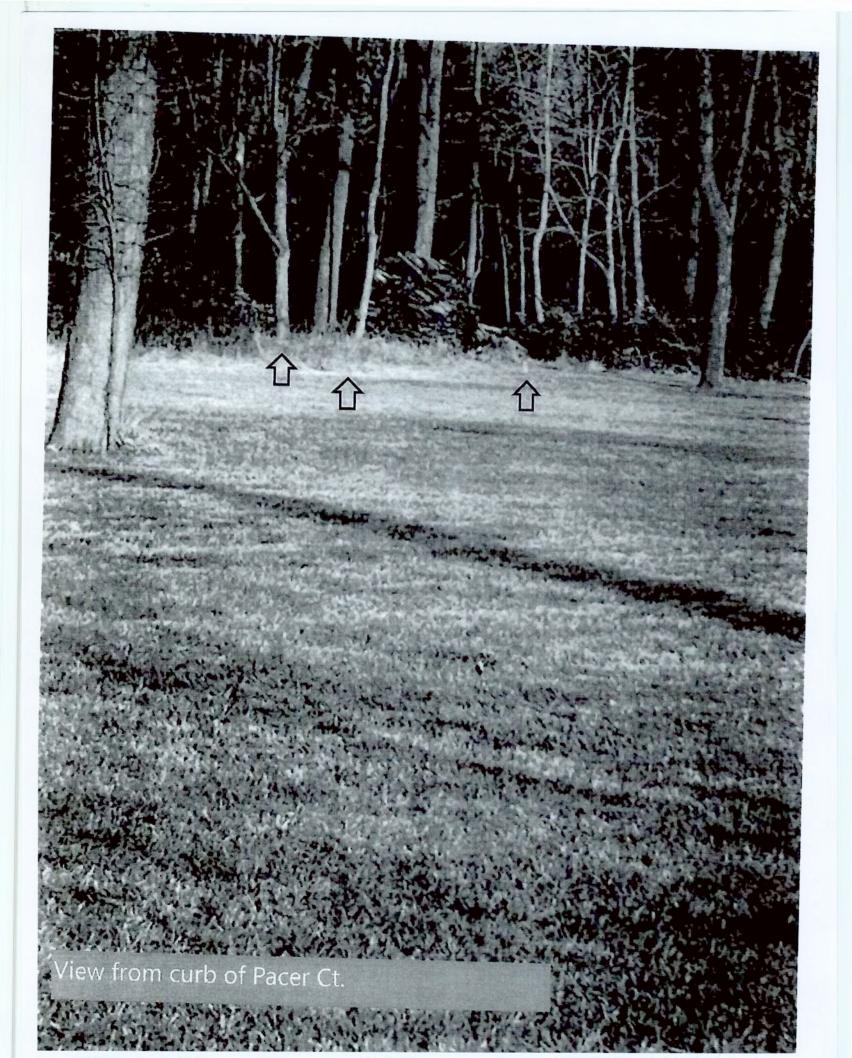


APPENDIX D, ARTICLE III

Checklist

Application for Approval of a Variance Pursuant to NJSA 40:55D-70(c)
Important: Each item must be marked Submitted, Not Applicable or Waiver Requested

No.	Important: Each item must be marked Submitted, No	Submitted	Not Applicable	Waiver Requested
1	A completed application form and checklist.	Jubilitted	Аррисиви	requestes
2	A certificate from the tax collector indicating that taxes are paid.			
3	All required application and escrow deposit fees.	~		
4	Names and addresses of property owners within 200' of the subject property, as disclosed by current tax records and identified by block & lot numbers.			
5	A plot plan or survey accurately depicting the entire subject property and all existing buildings, structures, driveways, patios, etc.	V		
6	Sketch of all proposed improvements on the plot plan or survey, with dimensions of improvements and distances to property lines.	~		
7	Calculations of existing & proposed lot coverage percentages.			
8	Architectural sketches (floor plan and elevations) of the proposed improvements.	V		
9	Photographs of the property in the location of the proposed improvements.	~		
10	A wetlands delineation or wetlands absence determination prepared by a qualified consultant and verified by a letter of interpretation from the New Jersey Department of Environmental Protection, if required pursuant to Section 21-14.1.a.			
11	The locations of percolation tests and a copy of the written approval of the tests and locations from the Bernards Township Health Department, if the application involves a new dwelling and sewage disposal is to be handled by an individual septic system.			
12	Delineations of existing and proposed stream buffer conservation areas and stream buffer management plans, if required pursuant to Section 21-14.4.b.		V	
13	Existing topography, proposed grading, and proposed stormwater infiltration measures in accordance with §21-42.1.f.2(b), shown on the plot plan or survey, if 1,000sf or more of new impervious area is proposed.			

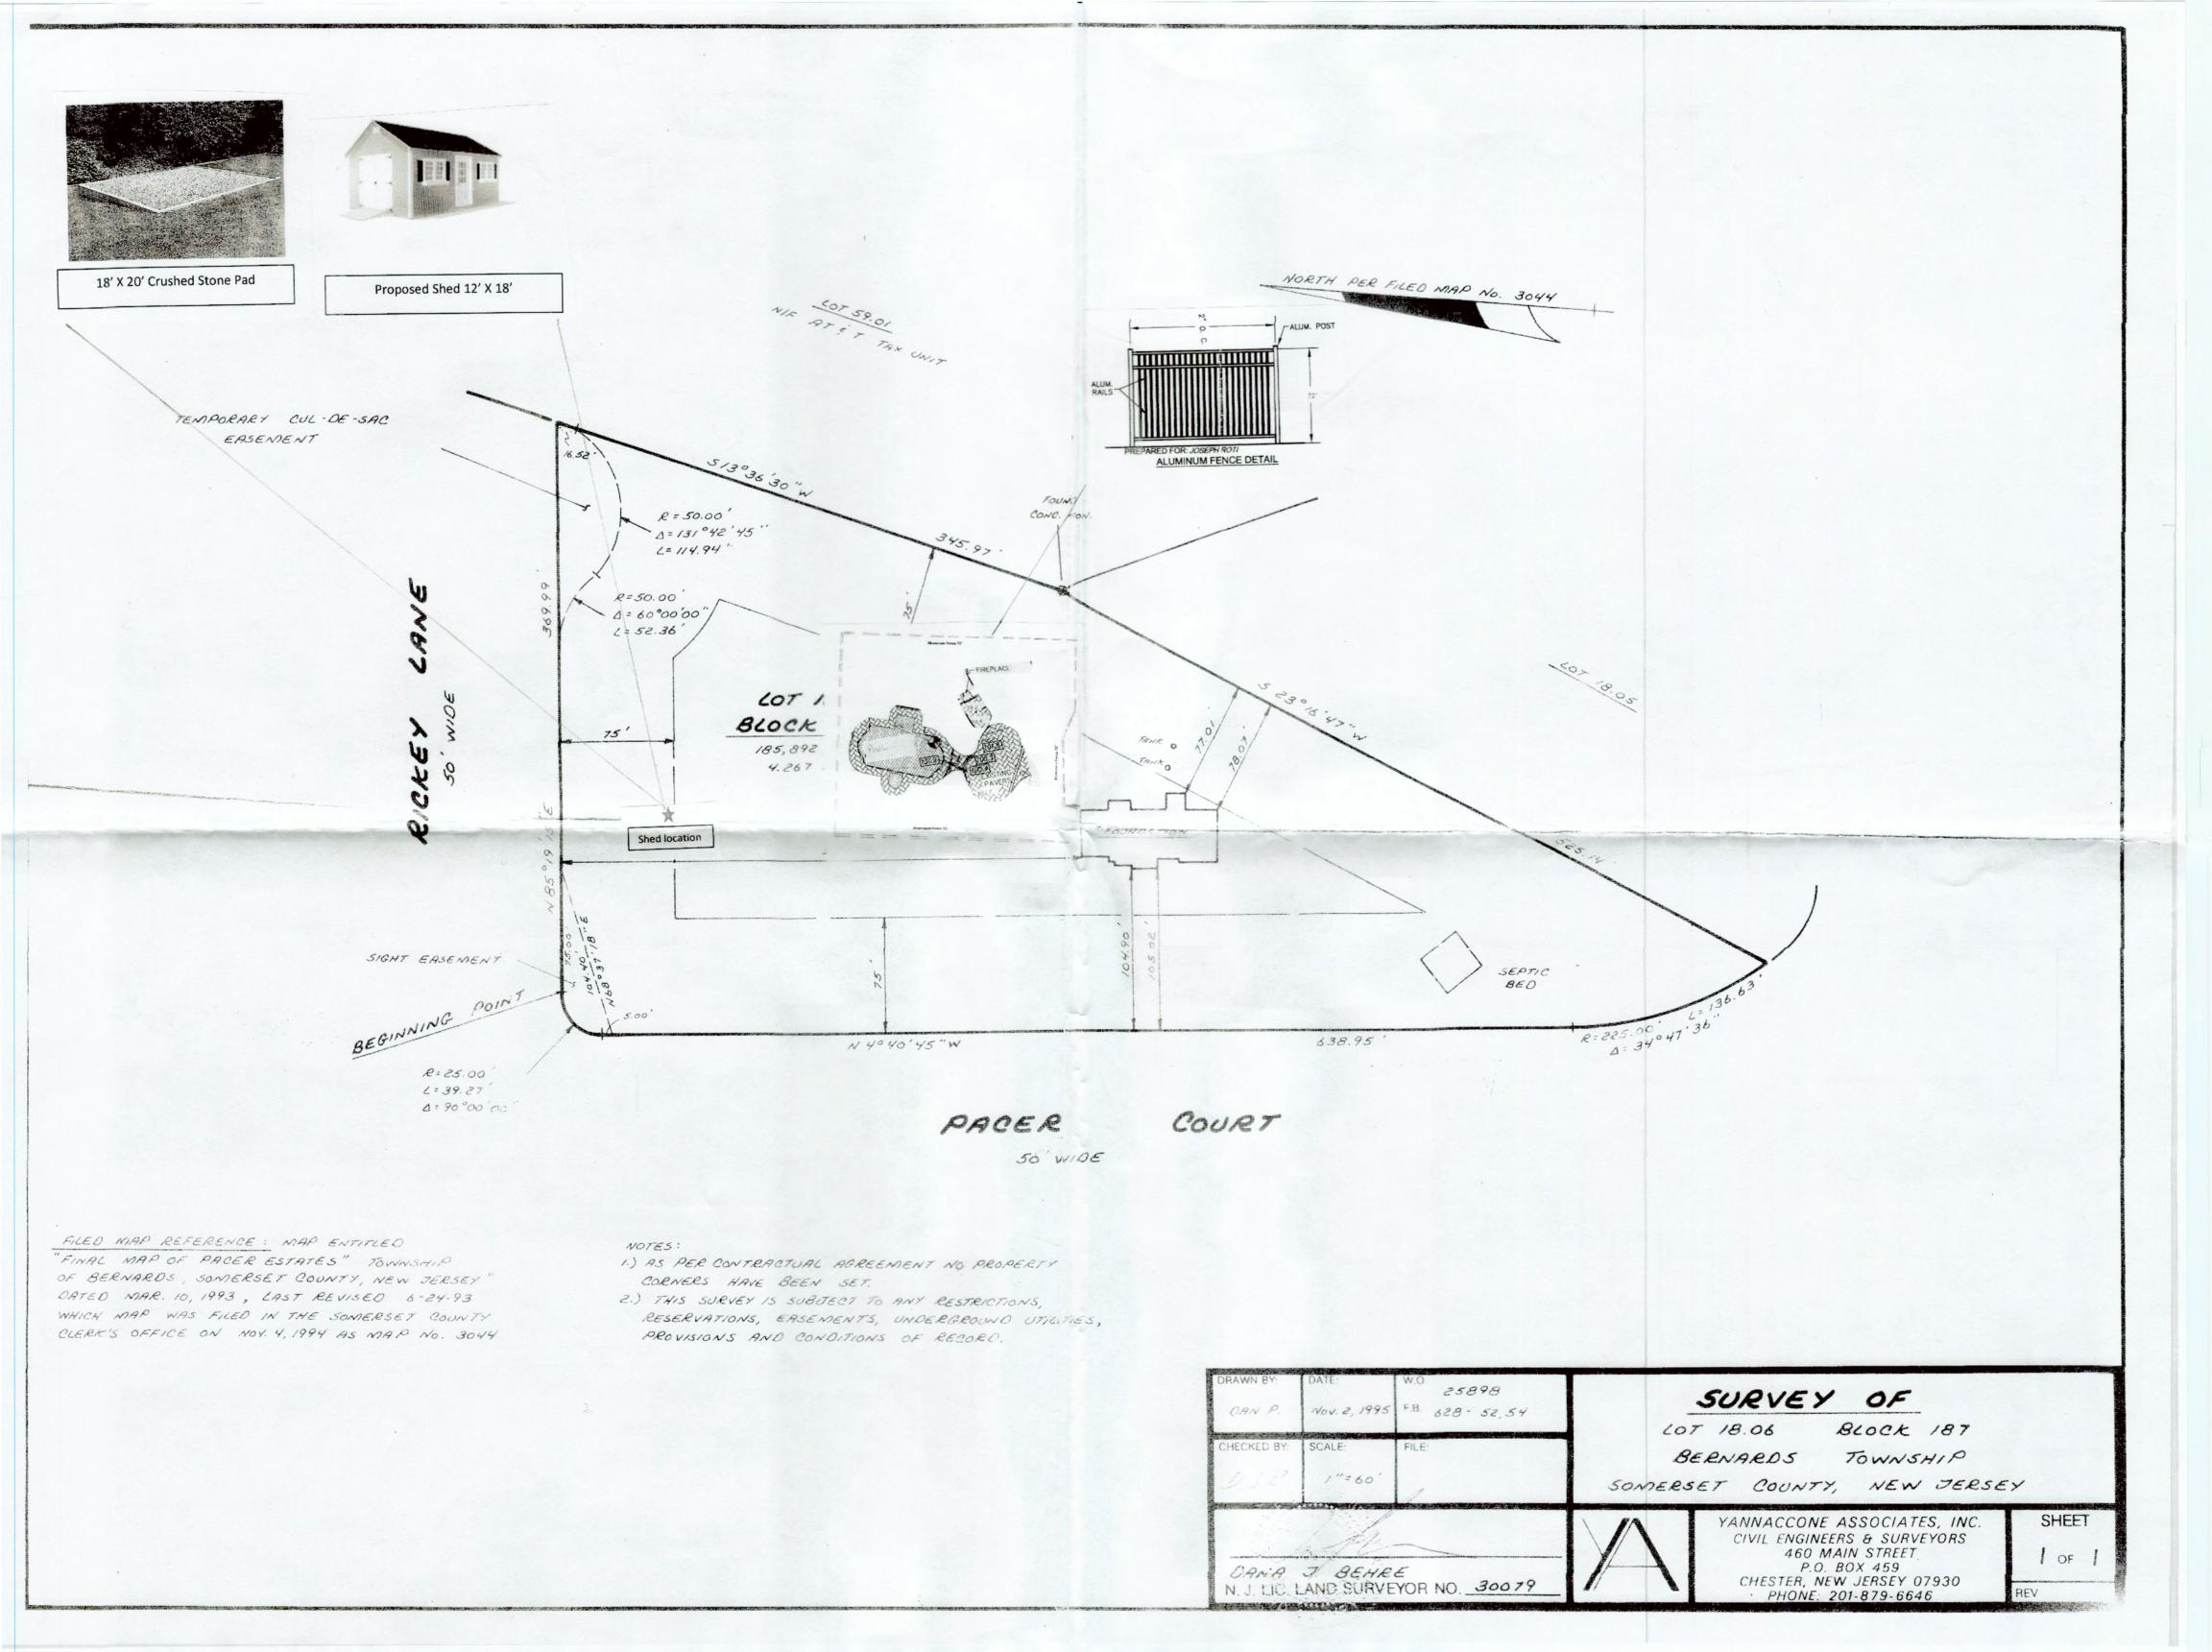



Application No: ZBZ 2005 Block: 270	. /		
Applicant: BURCAT, JOSEPILS ADRIENNE			
Address of Property: 153 SPENCER ROAD			
Description: (c) VARIANCE TO	DR FRONTYARD SETBACK		
(ADDITION) AND FOR PO	DOLNOT LOCATED BEHINT		
REAR BUILDING LINE OF	DIACENT DWELLINGS		
APPLICATIO	N CHECKLIST		
Original + 16 copies of Application W-9 Site Visit Consent (A) Ownership Form (B) 200' Property Search List (C) Tax Certification (D) Notice to be Served/Published (E) Dimensional Statistics Form (F) Contributions Disclosure Form (G)	Engineering Plan/Plot Plan Architectural Plans Survey Photographs Wetlands Report/LOI Application Fee Escrow Deposit Imaging Fee Tax Map Revision Fee Checklist		
SCHEDULING	HEARING		
Original Submission Date 60 Completeness Deadline (45 days) Incomplete Date Resubmission Date Date Complete Date Complete Time to Act (45/95/120 days)	Notice to Property Owners Date of Publication Completeness Hearing Public Hearing Carried to Date Decision - Approved/Denied Resolution Memorialized Resolution Published		
DISTRIBUTION Environmental Comm Fire Official LCFAS Police	NOTES		

TOWNSHIP OF BERNARDS 2021 ZONING BOARD OF ADJUSTMENT APPLICATION

Bulk or Dimensional ("c") Variance
1 APPLICANT Decate Addison & Russet
1. APPLICANT: Joseph and Adrienne Bureat Address: 153 Spencer Read, Basking Ridge, NJ 07920
Address: 15 5 Spencer Kead, Busking hide, NO 01/20
Phone: (home) 908-204-8908 (work) 732-565-5711 (mobile)
Email (will be used for official notifications): burcat@earthlink. net
2. OWNER (if different from applicant):
Address:
Phone: Email (will be used for official notifications):
3. ATTORNEY:
Address:
Phone: Email (will be used for official notifications):
4. OTHER PROFESSIONALS (Engineer, Architect, etc. Attach additional sheet if necessary):
Name: Dary Sears - ANDesign LLC Profession: Architecture - Design
Address: 36 Demares + Rd., Sparts, NJ 07871
Phone: 973 - 300 - 1100 Email (will be used for official notifications):
5. PROPERTY INFORMATION: Block(s): 270 Lot(s): 32 Zone: R2
Street Address: 153 Spences Rd Total Area (square feet/acres):
6. ARE THERE ANY PENDING OR PRIOR PLANNING BOARD OR BOARD OF ADJUSTMENT APPLICATIONS INVOLVING THE PROPERTY? [♣] No [] Yes (if yes, explain or attach Board resolution)
7. ARE THERE CURRENTLY ANY VIOLATIONS OF THE ZONING ORDINANCE INVOLVING THE PROPERTY? [] No [] Yes (if yes, explain)

Formi Deco	ly 3 bedroom 2 bath Karch with deck - add 2 5 tory so it
030	3 6 1 1 6 1 0 1 1 1 1 1 1 1 1 1 1 1 1 1 1
24.0	SCRIPTION OF THE EXISTING PROPERTY AND THE PROPOSAL/REQUEST: Single by 3 bedroom 2 bath Ranch with deck - add 2nd story so it into 2 story 4 bedroom 3.5 bath single family home with
VVV	ittorial deck, above ground pool & not tob on new deck
10. D	ESCRIPTION OF REQUESTED VARIANCES OR EXCEPTIONS (include Ordinance section no.):
12-15	ESCRIPTION OF REQUESTED VARIANCES OR EXCEPTIONS (include Ordinance section no.):
to y	wild on top
21-8	. I Pool shall be located behind rear building line of existing residential
11. T	HE FOLLOWING ARGUMENTS ARE MADE IN SUPPORT OF THE APPLICATION:
Horse	currently is in the setback and we are adding a second story is located on a sharp currein Road - rear line of neighboring is at a near 90° angle to ours.
H005	e is located on a sharp curve in Kood - rear line of neighborin
more	or is at a near 90° angle to ours.
12. N	OTARIZED SIGNATURES (ALL APPLICANTS AND OWNERS MUST SIGN):
APPI	JCANT(S) SIGN HERE:
I/we	the above statements and the statements contained in the materials submitted herewith are true and
all of	the above statements and the statements contained in the materials submitted herewith are true and
correc	
	A Tell
Signa	ture of Applicant(s):
Swor	rand subscribed before me, this day of JANUARY, 2021.
	CYNTHIA KIEFER
1	Notary Public - New Jersey Commission #2442187
Notar	Expires 01/10/24
CONTRACTOR	TED (C) CICKLYHEDE (IE ADDI ICANT IC NOT THE OWNED).
	TER(S) SIGN HERE (<u>IF APPLICANT IS NOT THE OWNER</u>):
If the	application is made by a person or entity other than the property owner, or by less than all of the property
owne	rs, then the property owner or the additional owners must complete the following:
I/we,	the owner(s) of the property described in this application,
hereh	y authorize to act as my/our agent for purposes of making
and p	rosecuting this application and I/we hereby consent to the variance relief (if any) granted and all
	tions of approval thereof.
Signa	ture of owner(s):
Course	n and subscribed before me, this day of, 20

TOWNSHIP OF BERNARDS PLANNING BOARD / BOARD OF ADJUSTMENT


SITE INSPECTION CONSENT FORM

a Adrienne
Applicant: Joseph BurcatApplication:
Block: 2701 Lot: 32
Street Address: 153 Spencer Rd
I, Joseph Burcol , owner of the above property, hereby acknowledge that, upon determination of completeness of the application, a site inspection may be scheduled with the Board for a mutually convenient date and time. I hereby authorize members of the Planning Board/Board of Adjustment and their representatives and consultants to enter onto the property at the time of the site inspection for the purpose of evaluating the application.
Signature: Date: 12/29/20


	REQUIRED	EXISTING	PROPOSED
LOT AREA	87,120 S.F.	79,554 S.F	No Change
LOT WIDTH	250'	229.1	No Chango
FRONTAGE	125	154'	No Change
FRONT YARD SETBACK	100.0	75.71	No Change
REAR YARD SETBACK	(00.01	+/-168.7	133.1'
COMBINED SIDE YARD	50' Per	136.5	117.5
SIDE YARD	R+ 50, 4+ 50,	RIGHT 25:21 Left -91131	No change light Left 923'
COVERAGE	1500 11,9935.F.	10.4 % 8633 S.F.	
HEIGHT	35 max	22.2'	29.75'
IF REQUIRED, GROSS FLOOR AREA			
IF REQUIRED, FLOOR AREA RATIO			
IF REQUIRED, IMPROVABLE LOT AREA			



Current Front Elevation

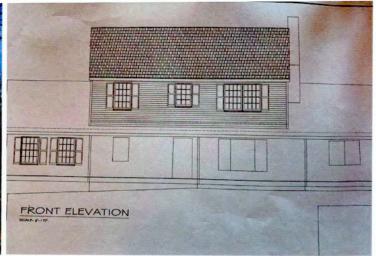

Same View Proposed Front Elevation

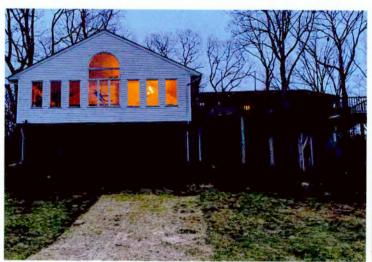

Current Rear Elevation




Same View Proposed Rear Elevation

Burcat - 153 Spencer Road Proposed 2 Car Carport in Existing Driveway




Existing Driveway on Left of House

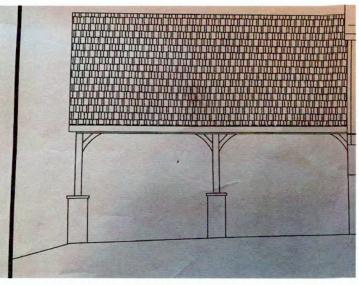

Proposed Carport in Existing Driveway




Current Elevation Driveway towards house

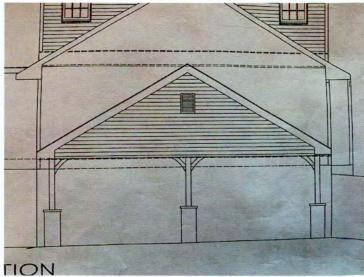


Proposed Elevation with Carport






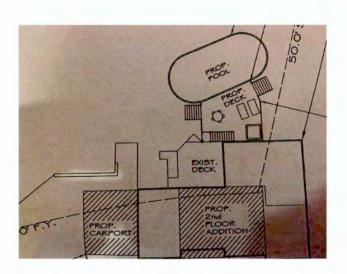

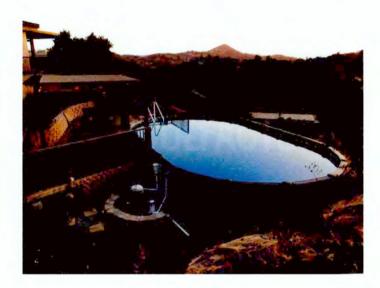



Burcat proposed above ground/in-ground pool. Photos of pools are for demonstration purposes only. This is an above ground/in-ground pool. Part of the pool will go in the ground. Pool dimensions 21'x 43'x 54" and it is a salt water pool.

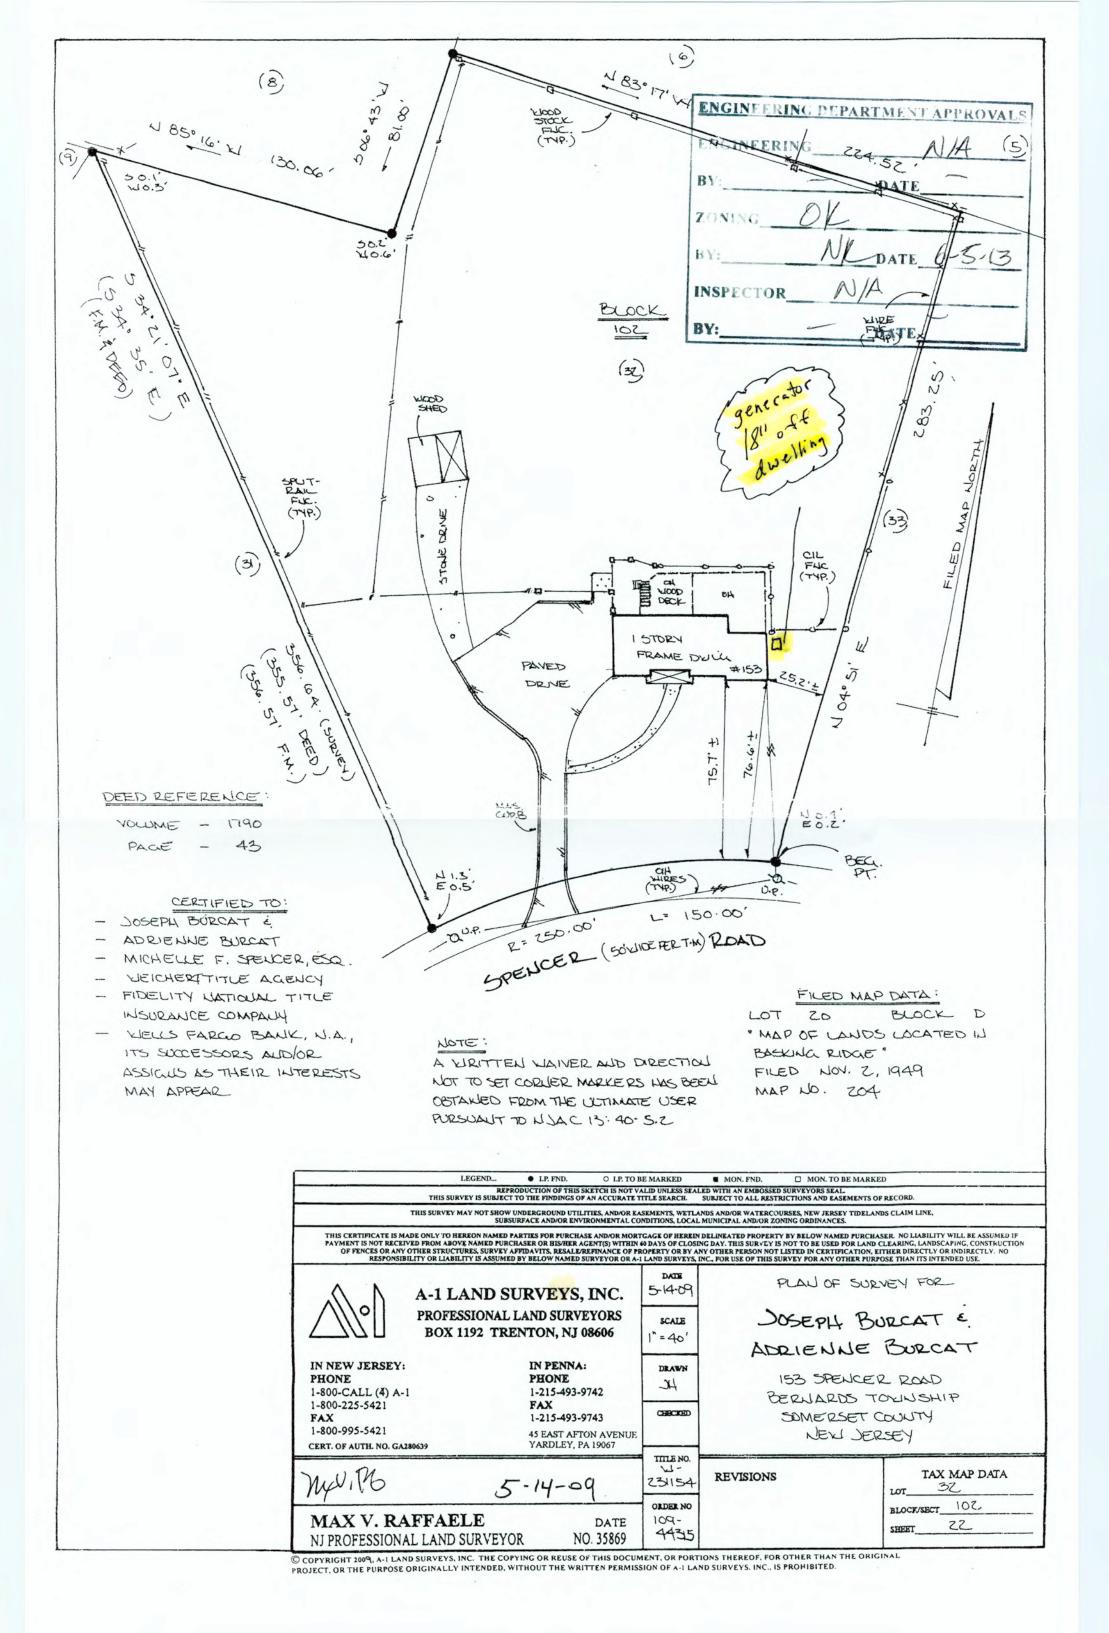

Not Waiver Submitted Applicable Requested No. Item V A completed application form and checklist. A certificate from the tax collector indicating that taxes are paid. All required application and escrow deposit fees. Names and addresses of property owners within 200' of the subject property, as disclosed by current tax records and identified by block & lot numbers. A plot plan or survey accurately depicting the entire subject property and all existing buildings, structures, driveways, patios, etc. Sketch of all proposed improvements on the plot plan or survey, with dimensions of improvements and distances to property lines. Calculations of existing & proposed lot coverage percentages. Architectural sketches (floor plan and elevations) of the proposed improvements. Photographs of the property in the location of the proposed improvements. A wetlands delineation or wetlands absence determination prepared by a qualified consultant and verified by a letter of interpretation from the New Jersey Department of Environmental Protection, if required pursuant to Section 21-14.1.a. The locations of percolation tests and a copy of the written approval of the tests and locations from the Bernards Township Health Department, if the application involves a new dwelling and sewage disposal is to be handled by an individual septic system. Delineations of existing and proposed stream buffer conservation areas and stream buffer management plans, if required pursuant to Section 21-14.4.b. Existing topography, proposed grading, and proposed stormwater infiltration measures in accordance with §21-42.1.f.2(b), shown on the plot plan or survey, if 1,000sf or more of new impervious area is proposed.

ADD'L MATO


Application 1	No: <u>ZBZ 005</u> Block: <u>270</u>	1 Lot: 32	Zone: 2-2
Applicant: _	BURCAT, JOSEPL	15 ADRIE	VNE
Address of P	roperty: 153 SPENC	ER ROAD	
Description:	(c) VARIANCE F	OR FRONT	YARD SETBACI
LADDIT	TION) AND FOR PO	DOLNOTLE	CATED BEHIN
REAR	BUILDING LINE O	FADIACE	IT DWELLING
	APPLICATIO	N CHECKLIST	
W-9 Site Owr 200' Tax Noti	Visit Consent (A) nership Form (B) Property Search List (C) Certification (D) ice to be Served/Published (E) nensional Statistics Form (F) tributions Disclosure Form (G)	Archit Survey Photog Wetlan Applic Escroy	graphs ands Report/LOI cation Fee v Deposit ng Fee lap Revision Fee
	SCHEDULING		HEARING
1-14-21 3-15-21 5-14-21	Original Submission Date Completeness Deadline (45 days) Incomplete Date Resubmission Date Date Complete Time to Act (45/95/120 days)	Da Co	otice to Property Owners the of Publication ompleteness Hearing oblic Hearing orried to Date orision - Approved/Denied orisolution Memorialized orisolution Published
	DISTRIBUTION		NOTES
1.14.21	Environmental Comm Fire Official LCFAS Police		

Burcat - 153 Spencer Road. Application Addendum for Side Yard Set Back Variance


21-15.1 (d)1 table 501 -Application Addendum for Side Yard Set Back Variance - Required is 50', currently house is located 25.2' from east (right) side yard setback. The proposed 2nd floor addition side yard setback from the right side would be 42' thus requiring a variance.


Burcat - 153 Spencer Rd Proposed Above Ground/In-Ground Pool Placement



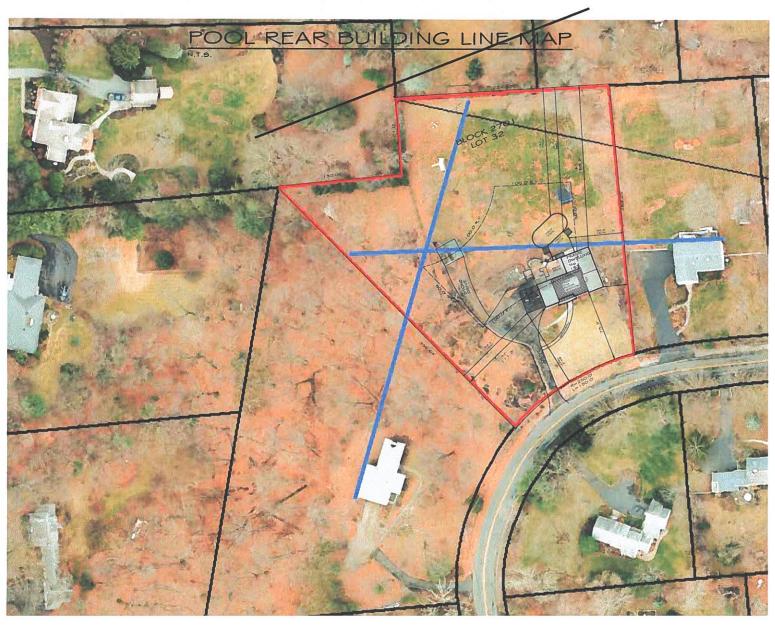

Burcat - 153 Spencer Rd. Proposed Hot Tub Placement

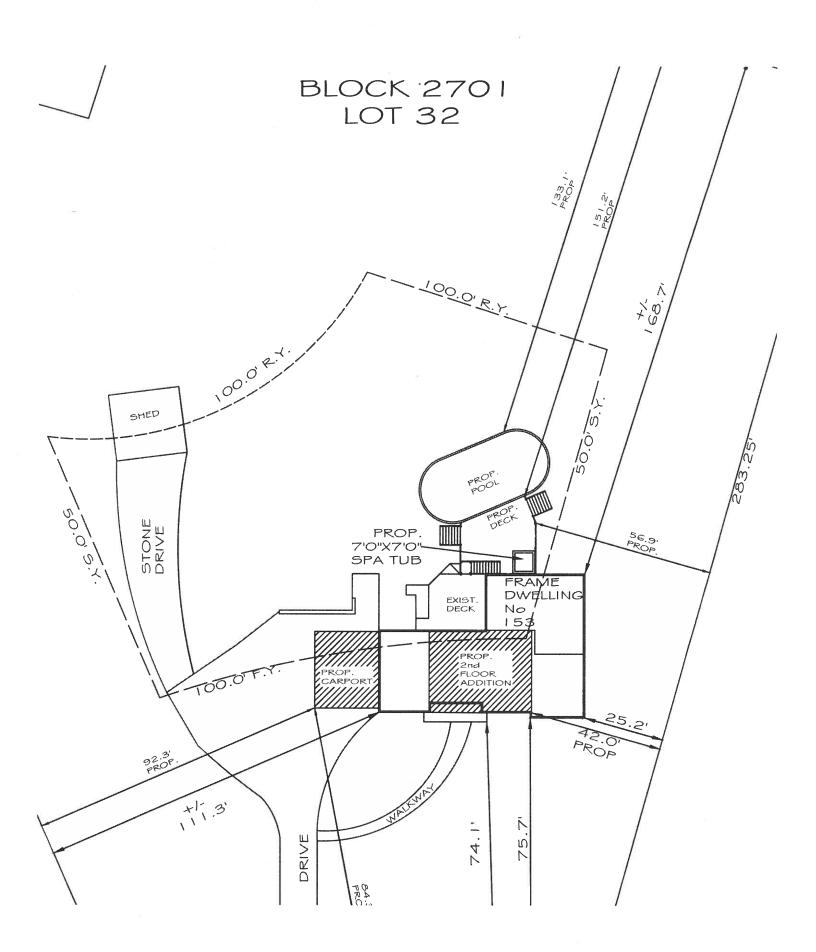

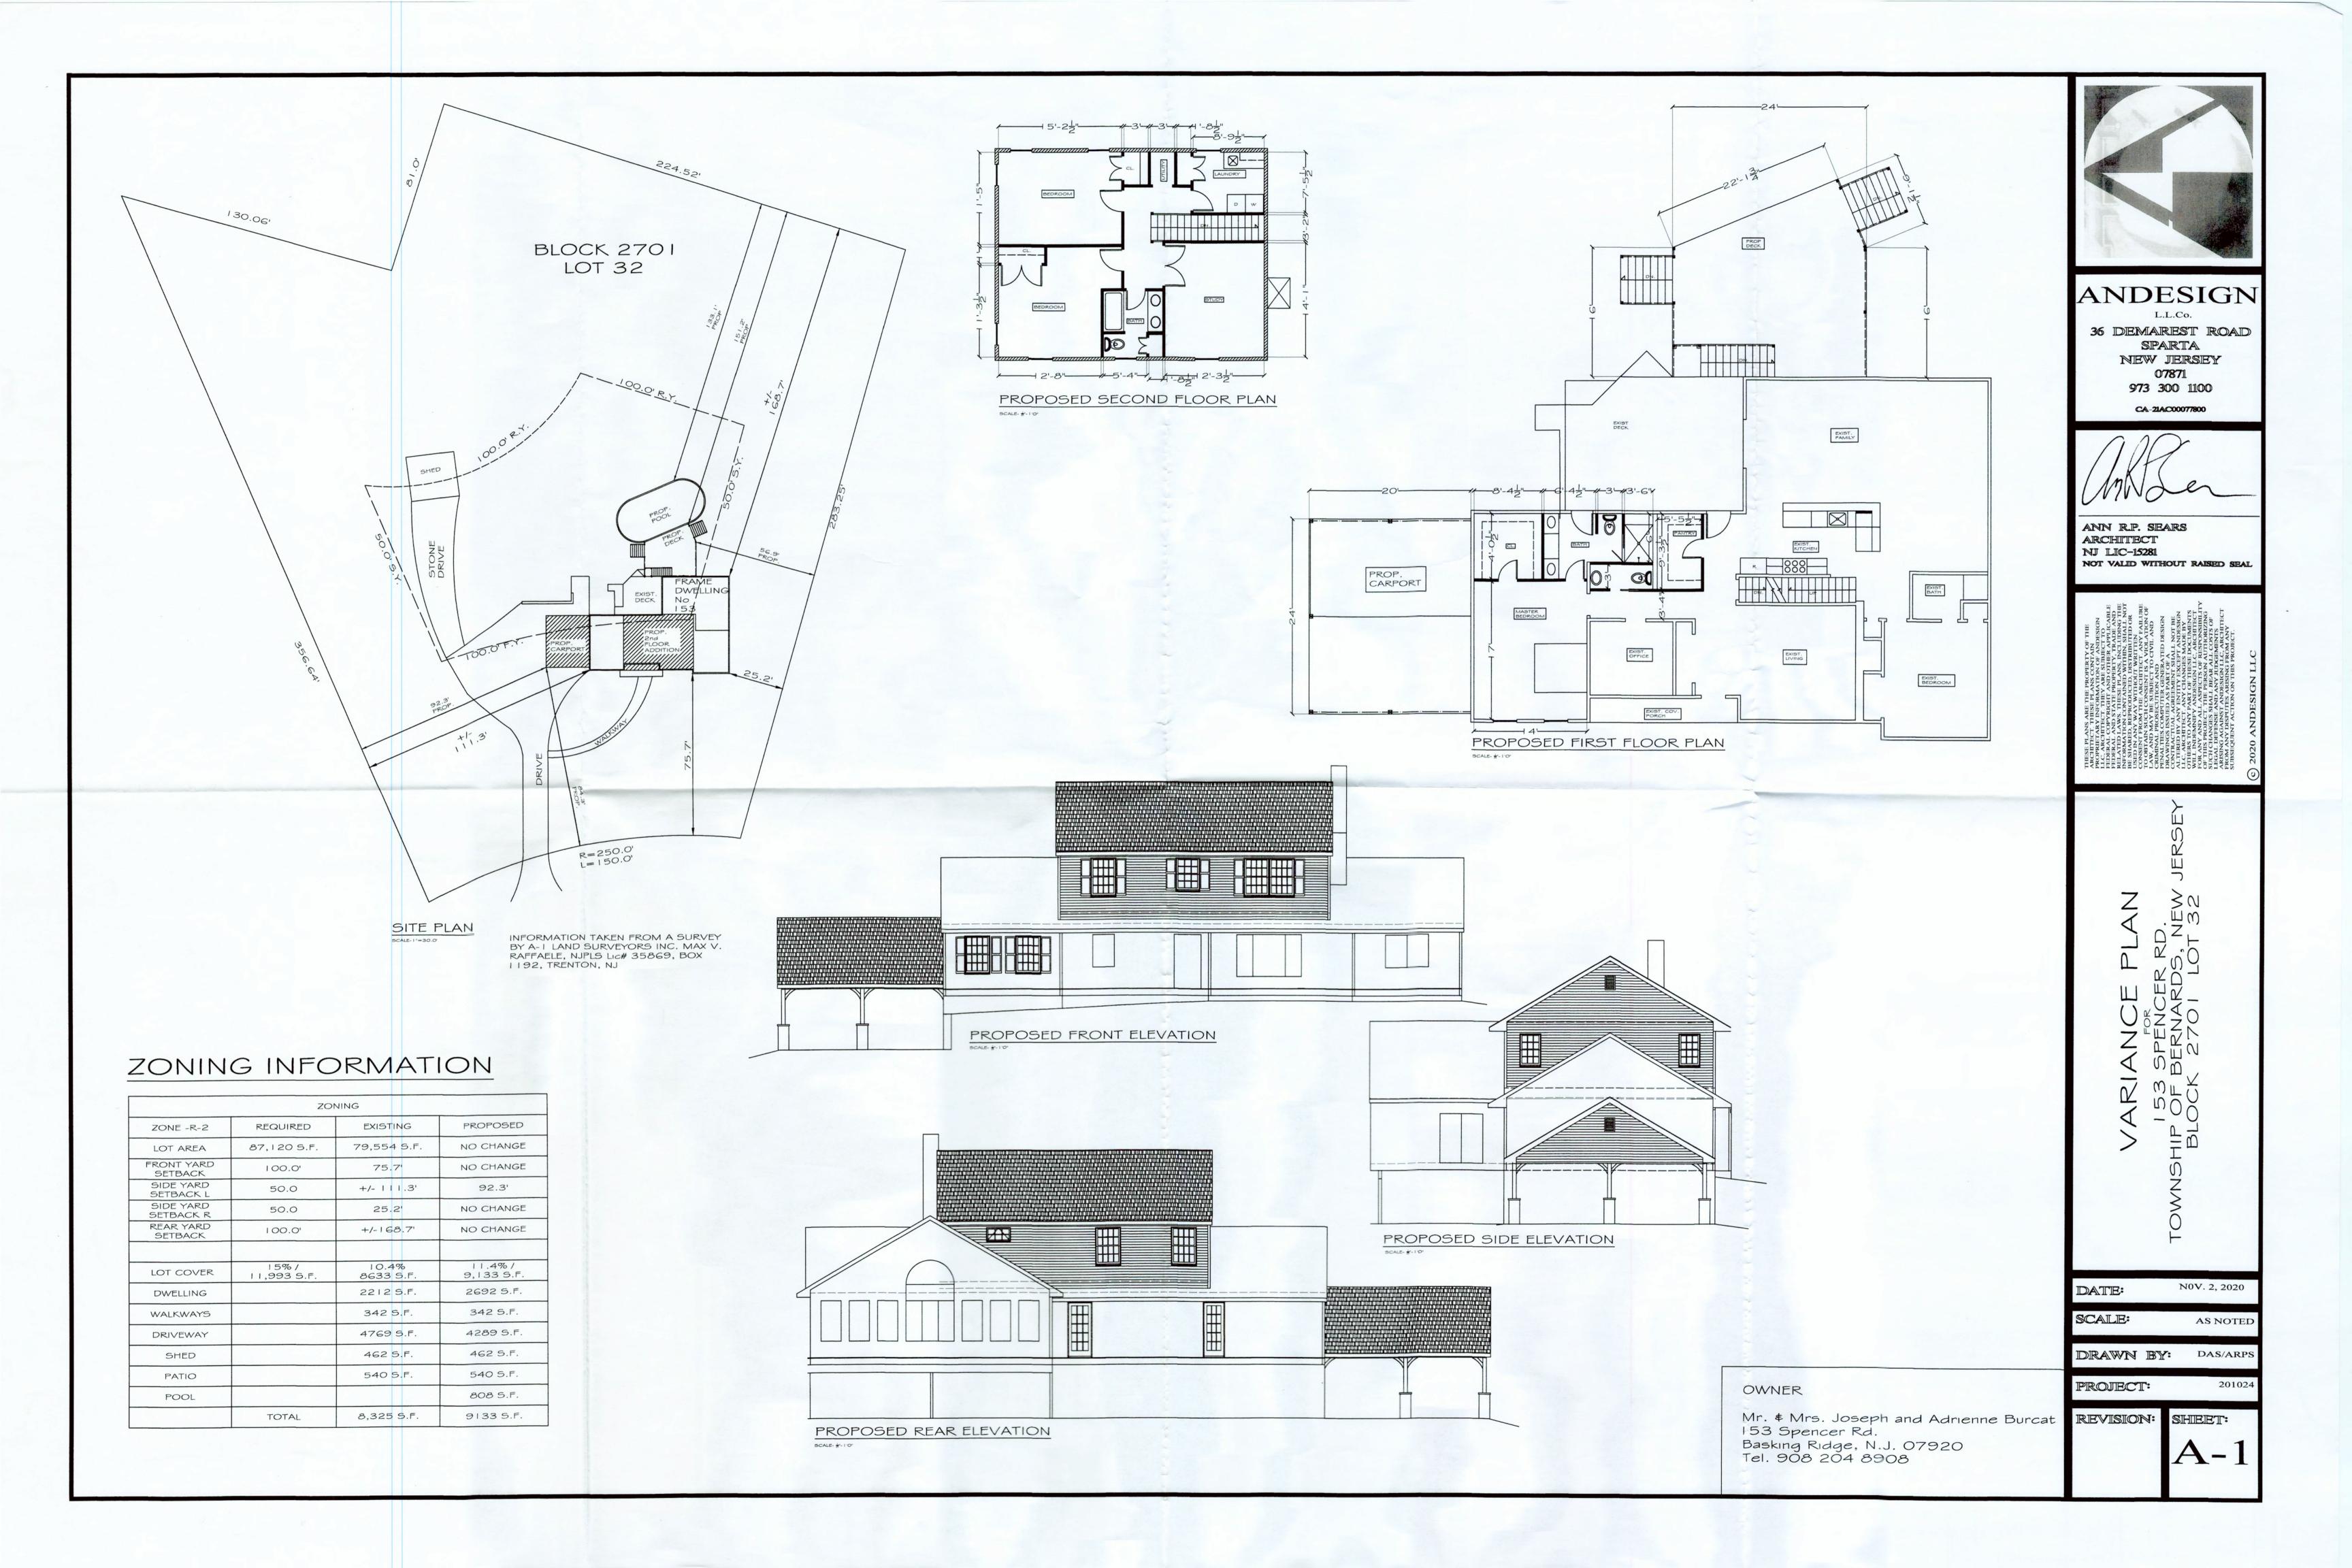

REVIHED

Application No: 282/006 Block: 500	1 Lot: 21 Zone: 2-4
Applicant: ROSENBLAT, MA	PC & RACHEL
Address of Property: 30 CAMER	on court
Description: (C) POOL NOT LC	XATED BELLIND THE REAR
BUILDING LINE OF ADJACEN	JT DWELLINGS
. 0	
APPLICATIO	N CHECKLIST
Original + 16 copies of Application W-9 Site Visit Consent (A) Ownership Form (B) 200' Property Search List (C) Tax Certification (D) Notice to be Served/Published (E) Dimensional Statistics Form (F) Contributions Disclosure Form (G)	Engineering Plan/Plot Plan Architectural Plans Survey Photographs Wetlands Report/LOI Application Fee Escrow Deposit Imaging Fee Tax Map Revision Fee Checklist
SCHEDULING	HEARING
Original Submission Date Completeness Deadline (45 days) Incomplete Date Resubmission Date Date Complete Date Complete Time to Act (45/95/120 days)	Notice to Property Owners Date of Publication Completeness Hearing Public Hearing Carried to Date Decision - Approved/Denied Resolution Memorialized Resolution Published
DISTRIBUTION Environmental Comm Fire Official LCFAS Police	NOTES

TOWNSHIP OF BERNARDS 2021 ZONING BOARD OF ADJUSTMENT APPLICATION

Bulk or Dimensional ("c") Variance Appeal of Zoning Officer's Decision Use ("d") Variance Interpretation of Zoning Ordinance Conditional Use ("d") Variance Minor Subdivision Floor Area Ratio, Density, or Height ("d") Variance Major Subdivision - Preliminary / Final Site Plan - Preliminary / Final Other (specify):
1. APPLICANT: MR. MARC POSENBLATT + MRS PACHEL ROSENBLATT
Address: 30 CAMERON COURT BASKING RIDGE, NJ 07920
Phone: (home) 646 483 1078 (work) — (mobile) 646 207 6867
Email (will be used for official notifications): <u>PACHELANN ROENBLATTER MADE.</u> Com
2. OWNER (if different from applicant):
Address:
Phone: Email (will be used for official notifications):
3. ATTORNEY:
Address:
Phone: Email (will be used for official notifications):
4. OTHER PROFESSIONALS (Engineer, Architect, etc. Attach additional sheet if necessary):
Name: DAUZD FATZNA Profession: ENGINEER
Address: 15 SUNCET DRIVE, REPNATOCIVILE, NJ 07924 DEATINA DEATINA
Phone: 908-616-9598 Email (will be used for official notifications): ENGINEERING, COM
5 PROPERTY INFORMATION: Block(s): 500 Lot(s): 2 Zone: 2-L
Street Address: 30 CAMERON COOLT Total Area (square feet/acres): 1.367 ACRES
6. ARE THERE ANY PENDING OR PRIOR PLANNING BOARD OR BOARD OF ADJUSTMENT APPLICATIONS INVOLVING THE PROPERTY? [X] No [] Yes (if yes, explain or attach Board resolution)
7. ARE THERE CURRENTLY ANY VIOLATIONS OF THE ZONING ORDINANCE INVOLVING THE PROPERTY? No [] Yes (if yes, explain)

8. ARE THERE ANY DEED RESTRICTIONS OR EASEMENTS AFFECTING THE PROPERTY? [No [] Yes (if yes, explain)
• •
9. DESCRIPTION OF THE EXISTING PROPERTY AND THE PROPOSAL/REQUEST:
EXISTING RESIDENTIAL PROPERTY WITH EXISTING 2 STORY FRAME
DUELLONG SEEKONG TO ONITHY A PROVATE SW2 MMZNG POOL
10. DESCRIPTION OF REQUESTED VARIANCES OR EXCEPTIONS (include Ordinance section no.):
11. THE FOLLOWING ARGUMENTS ARE MADE IN SUPPORT OF THE APPLICATION: THE PROPOSED POOL IN TO RE CENTRALLY LOCATED WITHIN THE REAR YARD OF THE SUBJECT PROPERTY AND STORM WATER IS TO BE CONSCRET
AND STORED DU-SITE THEREBY POSZUM NO DETRINENT, NEITHER PHYSICAL NOR VISUAL TO ADDACENT PROPERTIES. 12. NOTARIZED SIGNATURES (ALL APPLICANTS AND OWNERS MUST SIGN):
APPLICANT(S) SIGN HERE:
I/we, MARC ROSENBUATT and RACHEL ROSENBUATT hereby depose and say that all of the above statements and the statements contained in the materials submitted herewith are true and correct.
Signature of Applicant(s): Sworn and subscribed/before me, this 19th day of 2021.
JEANNIE L WILLIAMS Notary Public - State of New Jersey My Commission Expires Jan 29, 2022
OWNER(S) SIGN HERE (<i>IF APPLICANT IS NOT THE OWNER</i>):
If the application is made by a person or entity other than the property owner, or by less than all of the property owners, then the property owner or the additional owners must complete the following:
I/we, the owner(s) of the property described in this application,
hereby authorize to act as my/our agent for purposes of making and prosecuting this application and I/we hereby consent to the variance relief (if any) granted and all conditions of approval thereof.
Signature of owner(s):
Sworn and subscribed before me, this day of, 20
Notary

Township of Bernards

2021 Zoning Board of Adjustment Application

Supplementary Attachment 1

Page 2 of 2

Line Item #10:

Applicant seeks relief from Ordinance Section 21.18.1 requiring swimming pools to be located behind the rear line of dwellings located on adjacent lots.

The applicant seeks relief from Ordinance Section 21-15.1(d)1 and Table 501 limiting lots in the R-4 zone to a maximum of 15% of the lot area covered with impervious surface.

Line Item #11:

Variance Request #1: Ordinance Section 21.18.1

The proposed pool has been centrally located within the rear yard of the subject property. It is to be surrounded with landscaping and all stormwater runoff resulting from the proposed increase of impervious coverage is to be collected and stored on-site. It is for these reasons that we believe the proposed improvements pose no detriment, neither physical or visual, to adjacent properties.

Variance Request #2: Ordinance Section 21-15.1(d)1 and Table 501

The subject property experiences an impervious coverage hardship as a direct result of the culde-sac located at the Westernmost end of Cameron Court being partially within the limits of the subject property. If the area of the cul-de-sac located on the subject property (354 sf) was not counted against the applicants, the proposed developments would be within the 15% maximum allowable impervious coverage limit as regulated under Section 21-15.1(d)1 and Table 501.

TOWNSHIP OF BERNARDS

ZONING BOARD OF ADJUSTMENT

NOTICE OF HEARING ON APPEAL OR APPLICATION PLEASE TAKE NOTICE:

That the undersigned has filed an appeal or application for development with the Board of Adjustment of the Township of Bernards for a Type 'C' Variance from the requirements of Section 21-18.1 of the Bernards Township Zoning Ordinance so as to permit: The installation of a private swimming pool in the rear yard of an existing residential lot where the pool will not be located behind the rear line of an existing dwelling located on an adjacent lot as is required by Section 21-18.1. and Section 21-15.1(d)1 and Table 501 limiting properties within the R-4 zone to 15% maximum allowable impervious coverage any other variances the Board may deem necessary, on the premises located at #30 Cameron Court and designated as Block 5001, Lot 21, on the Township Tax Map, and this notice is sent to you as an owner of property in the immediate vicinity.

A public hearing has been set for March 3, 2021, at 7:30 p.m. or as soon thereafter as the matter may be reached, in the Municipal Building, 1 Collyer Lane, Basking Ridge, New Jersey, and, when the case is called, you may appear either in person, or by Attorney, and present any objections which you may have to granting of the relief sought in the petition.

The application and maps in support thereof are on file in the office of the Secretary, Planning Offices located at 277 South Maple Avenue, Monday through Friday, 8:30 AM to 4:30 PM and are available for inspection. If possible, call to make an appointment at (908) 204-3026.

The applicant, by order of the Board of Adjustment, sends this notice to you.

) ((G) (G) (G)

Marc and Rachel Rosenblatt



Application No: <u>ZB 21 000</u> Block: <u>5001</u> Lot: <u>21</u> Zone: <u>2-4</u>
Applicant: ROSENBLATT, MARC & RACHEL
Address of Property: 30 CAMERON COURT
Description: (C) POOL NOT LOCATED BELLIND THE REAR
BUILDING LINE OF ADJACENT DWELLINGS
. 0
APPLICATION CHECKLIST
Original + 16 copies of Application W-9 Site Visit Consent (A) Ownership Form (B) V 200' Property Search List (C) Tax Certification (D) Notice to be Served/Published (E) Dimensional Statistics Form (F) Contributions Disclosure Form (G) Engineering Plan/Plot Plan Architectural Plans Survey Photographs Wetlands Report/LOI Application Fee Escrow Deposit Imaging Fee Tax Map Revision Fee Checklist
SCHEDULING HEARING
DISTRIBUTION NOTES Environmental Comm Fire Official LCFAS Police

TOWNSHIP OF BERNARDS 2021 ZONING BOARD OF ADJUSTMENT APPLICATION

Bulk or Dimensional ("c") Variance [] Appeal of Zoning Officer's Decision [] Use ("d") Variance [] Conditional Use ("d") Variance [] Minor Subdivision
[] Floor Area Ratio, Density, or Height ("d") Variance [] Major Subdivision - Preliminary / Final [] Other (specify):
1. APPLICANT: MR. MARC ROSENBLATT + MRS. RACHEL ROSENBLATT
Address: 30 CAMERON COURT, BASKING RIDGE, NJ 07920
Phone: (home) 646-483-1098 (work) - (mobile) 646-207-6869
Email (will be used for official notifications): PACHEL ANN ROSEN RLATT & GMAZL. COM
2. OWNER (if different from applicant):
Address:
Phone: Email (will be used for official notifications):
3. ATTORNEY:
Address:
Phone: Email (will be used for official notifications):
4. OTHER PROFESSIONALS (Engineer, Architect, etc. Attach additional sheet if necessary):
Name: DAVID FANTINA Profession: ENGINEER
Address: 15 SUNSET DRZVE, BERNARDSUZLLE, NJ 67924
Phone: 908-696-9598Email (will be used for official notifications): DFATZNAR FANTINA
5. PROPERTY INFORMATION: Block(s): 5001 Lot(s): 21 Zone: 2-4
Street Address: 30 CAMERON COURT Total Area (square feet/acres): 1.387 ACRES
6. ARE THERE ANY PENDING OR PRIOR PLANNING BOARD OR BOARD OF ADJUSTMENT APPLICATIONS INVOLVING THE PROPERTY? No [] Yes (if yes, explain or attach Board resolution)
7. ARE THERE CURRENTLY ANY VIOLATIONS OF THE ZONING ORDINANCE INVOLVING THE PROPERTY? No [] Yes (if yes, explain)

No [] Yes (if yes, explain)
9. DESCRIPTION OF THE EXISTING PROPERTY AND THE PROPOSAL/REQUEST: EX 2512NG REST DENITIAL PROPERTY WATH EX 2512NG 2 STORY FRAME DWELLING SEEK 2NG TO 2NSTALL A PROJACE SWAMMANG POOL THAT WAY NOT BE LOCATED BEHOND REAR BUYLDONG LOVE OF ADDACENT ARABITATING. DWOLLDING.
10. DESCRIPTION OF REQUESTED VARIANCES OR EXCEPTIONS (include Ordinance section no.): PEQUESTAND RELATED REHAMD THE PLEME BULLDAND LANE OF DWENIANDS ON MODAGENT PROPERTIES.
11. THE FOLLOWING ARGUMENTS ARE MADE IN SUPPORT OF THE APPLICATION: THE PROPOSED POOL 25 TO BE CENTRALLY LOCATED WATHOUT THE REAR VARDOF THE SUBJECT PROPERTY AND STORM WATER 25 TO BE LONEUTED AND STORED ON-SITE THEREDY POSING NO DETAINENT, NEDTHER PHYSICAL NOR VISUAL TO PRODACENT PROPERTIES 12. NOTARIZED SIGNATURES (ALL APPLICANTS AND OWNERS MUST SIGN):
APPLICANT(S) SIGN HERE: I/we, MARC ROSENBLATT and PACIFIC ROSENBLATT hereby depose and say that all of the above statements and the statements contained in the materials submitted herewith are true and correct. Signature of Applicant(s): Sworn and subscribed before me, this 13 JEANNIE L WILLIAMS Notary Public - State of New Jersey My Commission Expires Jan 29, 2022
OWNER(S) SIGN HERE (IF APPLICANT IS NOT THE OWNER):
If the application is made by a person or entity other than the property owner, or by less than all of the property owners, then the property owner or the additional owners must complete the following:
I/we, the owner(s) of the property described in this application,
hereby authorize to act as my/our agent for purposes of making and prosecuting this application and I/we hereby consent to the variance relief (if any) granted and all conditions of approval thereof.
Signature of owner(s):
Sworn and subscribed before me, this day of, 20
Notary

TOWNSHIP OF BERNARDS PLANNING BOARD / BOARD OF ADJUSTMENT

SITE INSPECTION CONSENT FORM

Applicant: MARCH PACHEL ROSENBLATT
Block: 5 001 Lot: 21
Street Address: 30 CAMERON COURT, BASKING RIOGE, NO 07120
I, PACKET POSENBLATI, owner of the above property, hereby acknowledge that, upon determination of completeness of the application, a site inspection may be scheduled with the Board for a mutually convenient date and time. I hereby authorize members of the Planning Board/Board of Adjustment and their representatives and consultants to enter onto the property at the time of the site inspection for the purpose of evaluating the application.
Signature: Date:/_/3-2 /

DIMENSIONAL STATISTICS

	REQUIRED	EXISTING	PROPOSED
LOT AREA	IACRE	1.3872 ALRES	1.3872 ALRES
LOT WIDTH	200	164-24	164.24
FRONTAGE	100	75.29	75.29
FRONT YARD SETBACK	75	130.91	130.91
REAR YARD SETBACK	75	137.50	137.50
COMBINED SIDE YARD	50	66.75	66.15
SIDE YARD	20	22.65	22.65
COVERAGE	1590	10.8590	14.8790
HEIGHT	35	UNKOWN	TO REMAIN
IF REQUIRED, GROSS FLOOR AREA			
IF REQUIRED, FLOOR AREA RATIO			
IF REQUIRED, IMPROVABLE LOT AREA			4

APPENDIX D, ARTICLE III

Checklist

Application for Approval of a Variance Pursuant to NJSA 40:55D-70(c)
Important: Each item must be marked Submitted, Not Applicable or Waiver Requested

No.	Item	Submitted	Not Applicable	Waiver Requested
1	A completed application form and checklist.	X		
2	A certificate from the tax collector indicating that taxes are paid.	X		
3	All required application and escrow deposit fees.	X		
4	Names and addresses of property owners within 200' of the subject property, as disclosed by current tax records and identified by block & lot numbers.	X		
5	A plot plan or survey accurately depicting the entire subject property and all existing buildings, structures, driveways, patios, etc.	X		
6	Sketch of all proposed improvements on the plot plan or survey, with dimensions of improvements and distances to property lines.	Х		
7	Calculations of existing & proposed lot coverage percentages.	×		
8	Architectural sketches (floor plan and elevations) of the proposed improvements.			
9	Photographs of the property in the location of the proposed improvements.	×		
10	A wetlands delineation or wetlands absence determination prepared by a qualified consultant and verified by a letter of interpretation from the New Jersey Department of Environmental Protection, if required pursuant to Section 21-14.1.a.		×	
11	The locations of percolation tests and a copy of the written approval of the tests and locations from the Bernards Township Health Department, if the application involves a new dwelling and sewage disposal is to be handled by an individual septic system.		×	
12	Delineations of existing and proposed stream buffer conservation areas and stream buffer management plans, if required pursuant to Section 21-14.4.b.		×	
13	Existing topography, proposed grading, and proposed stormwater infiltration measures in accordance with §21-42.1.f.2(b), shown on the plot plan or survey, if 1,000sf or more of new impervious area is proposed.	×		




EXISTING CONDITIONS PHOTO #1



EXISTING CONDITIONS PHOTO #2




EXISTING CONDITIONS PHOTO #3

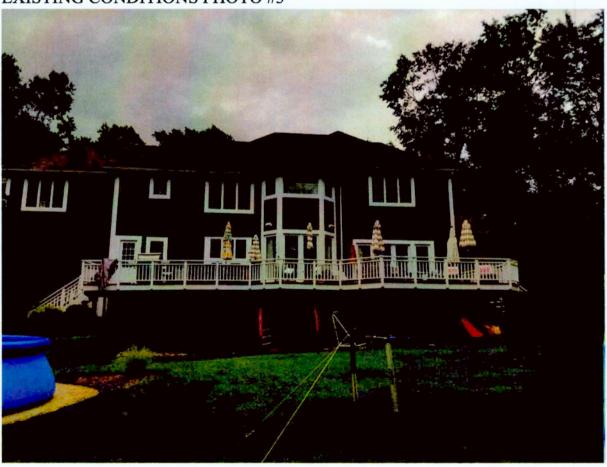

EXISTING CONDITIONS PHOTO #4



PROPOSED CONDITIONS PHOTO #1

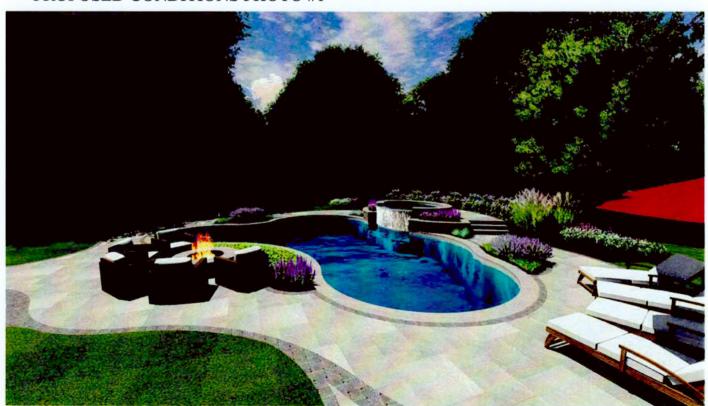


PROPOSED CONDITIONS PHOTO #2





PROPOSED CONDITIONS PHOTO #3



PROPOSED CONDITIONS PHOTO #4

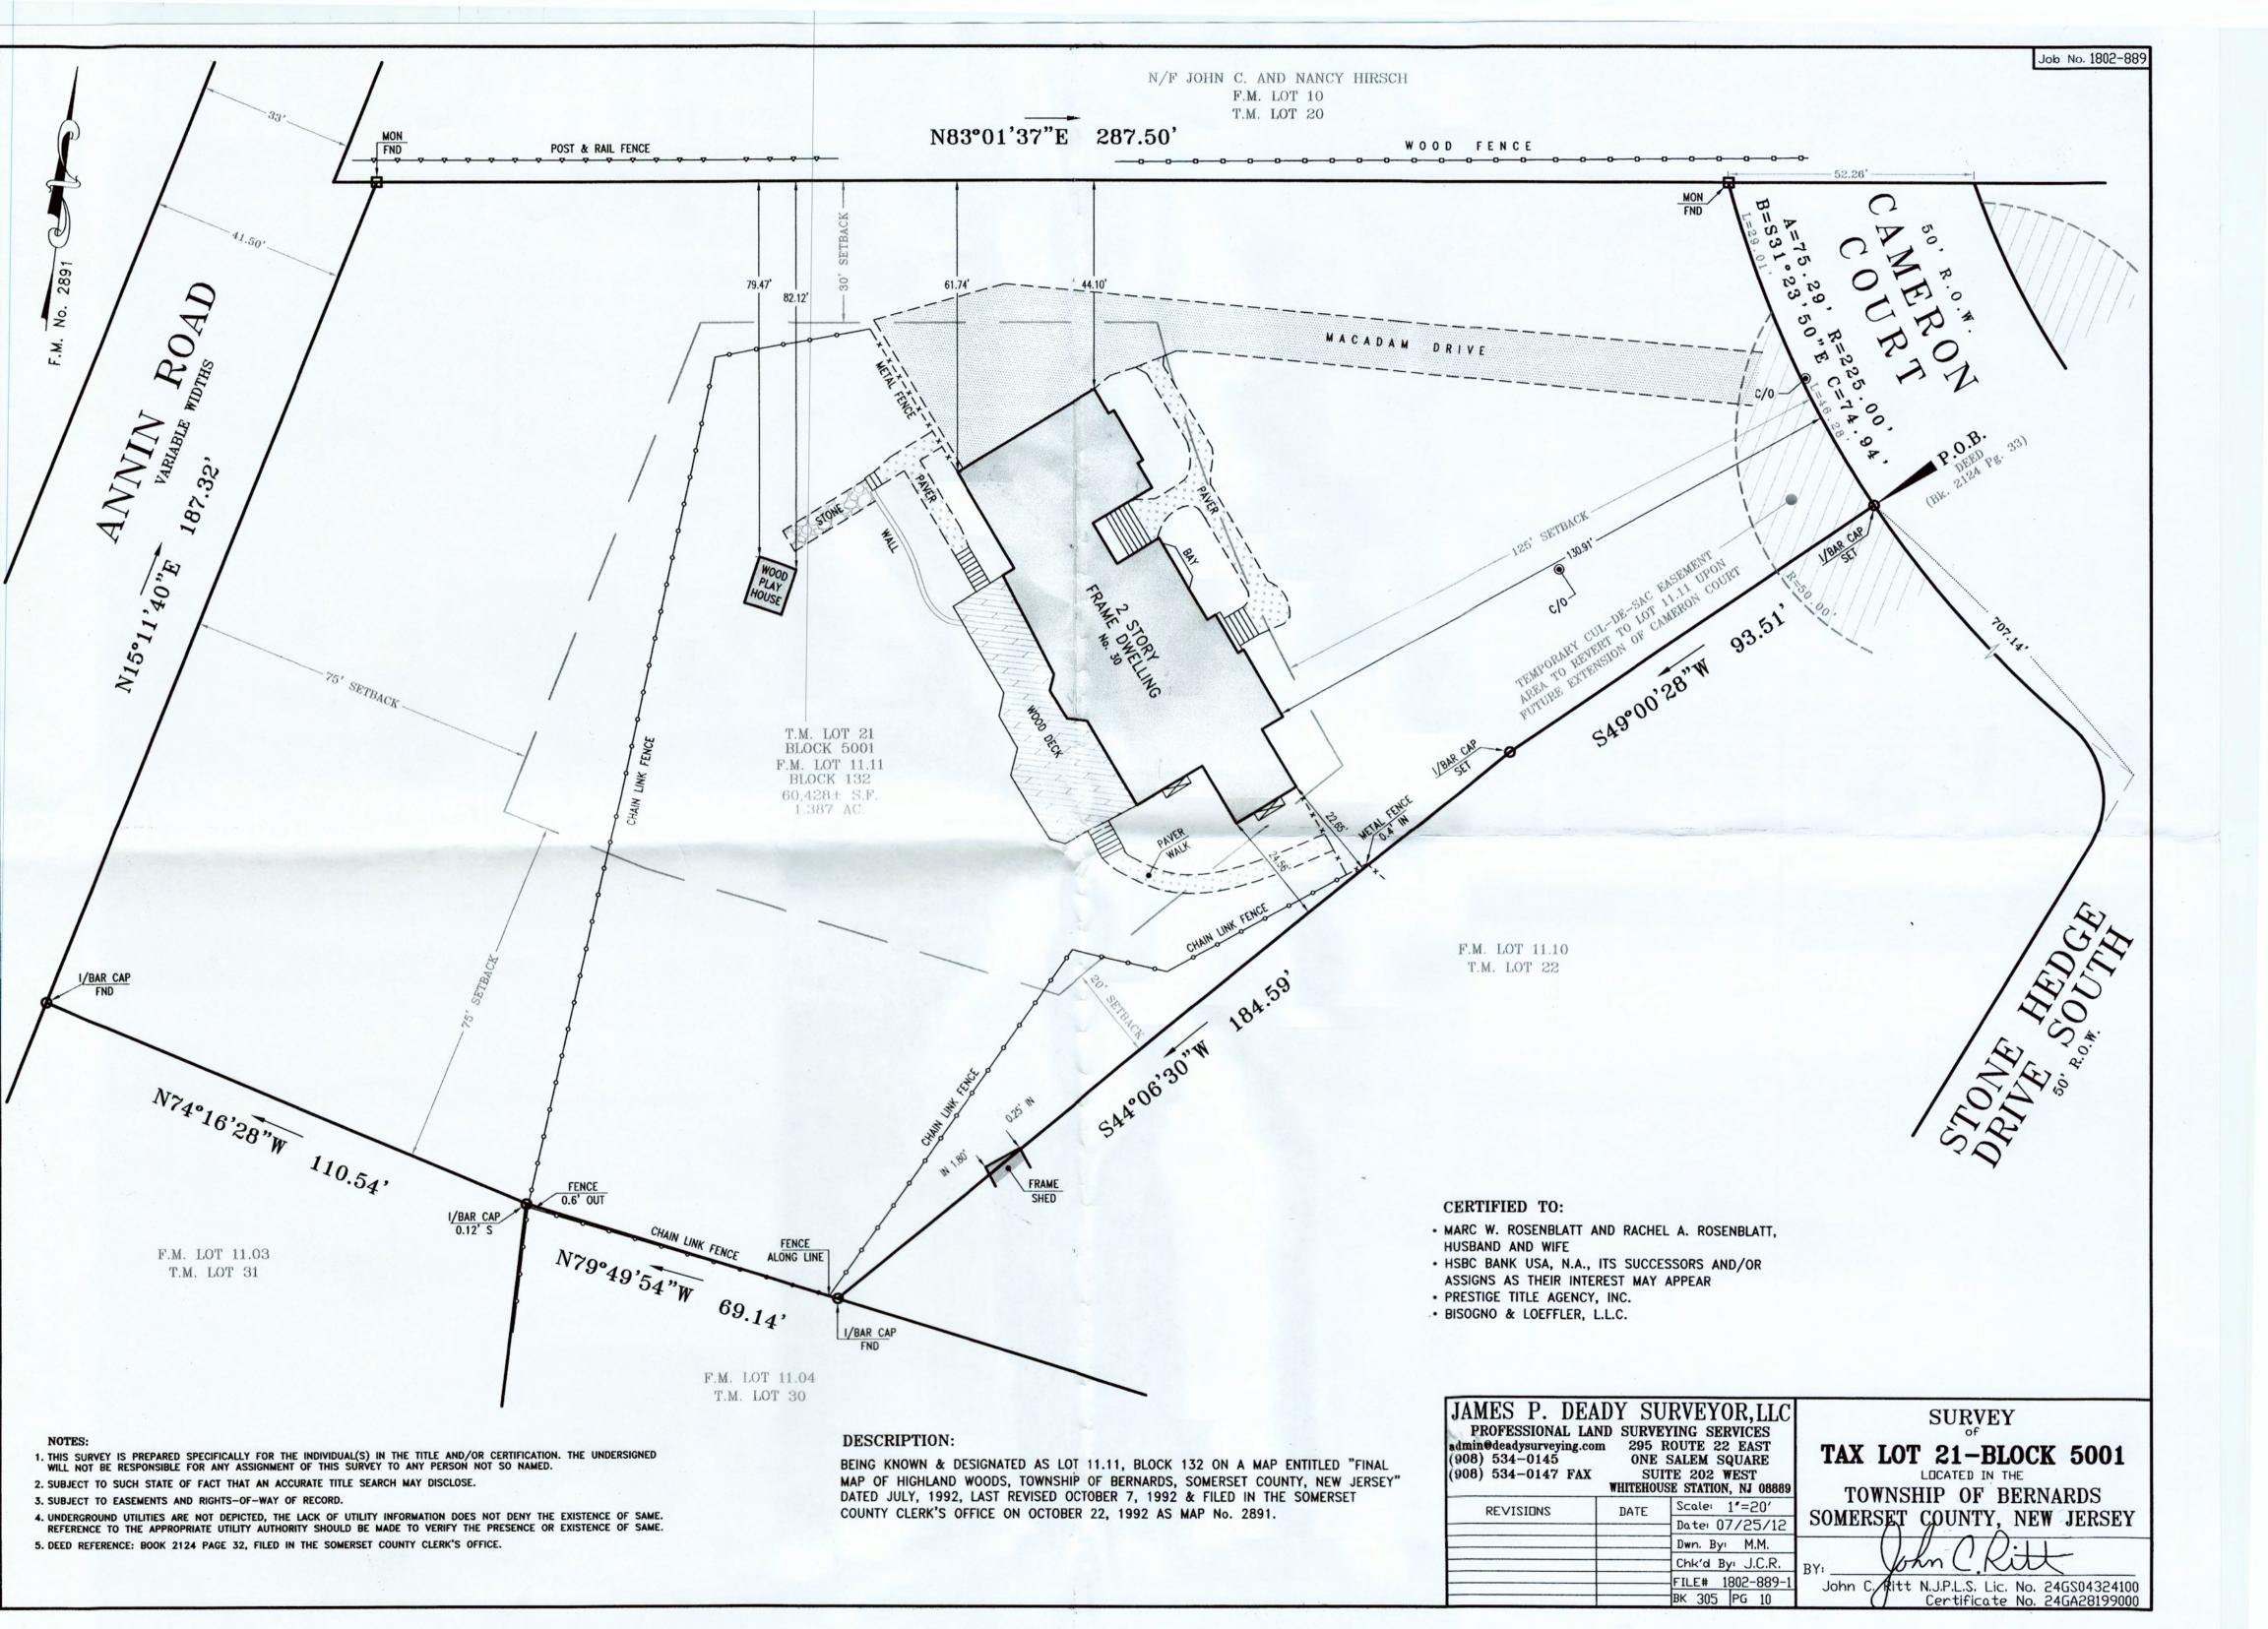

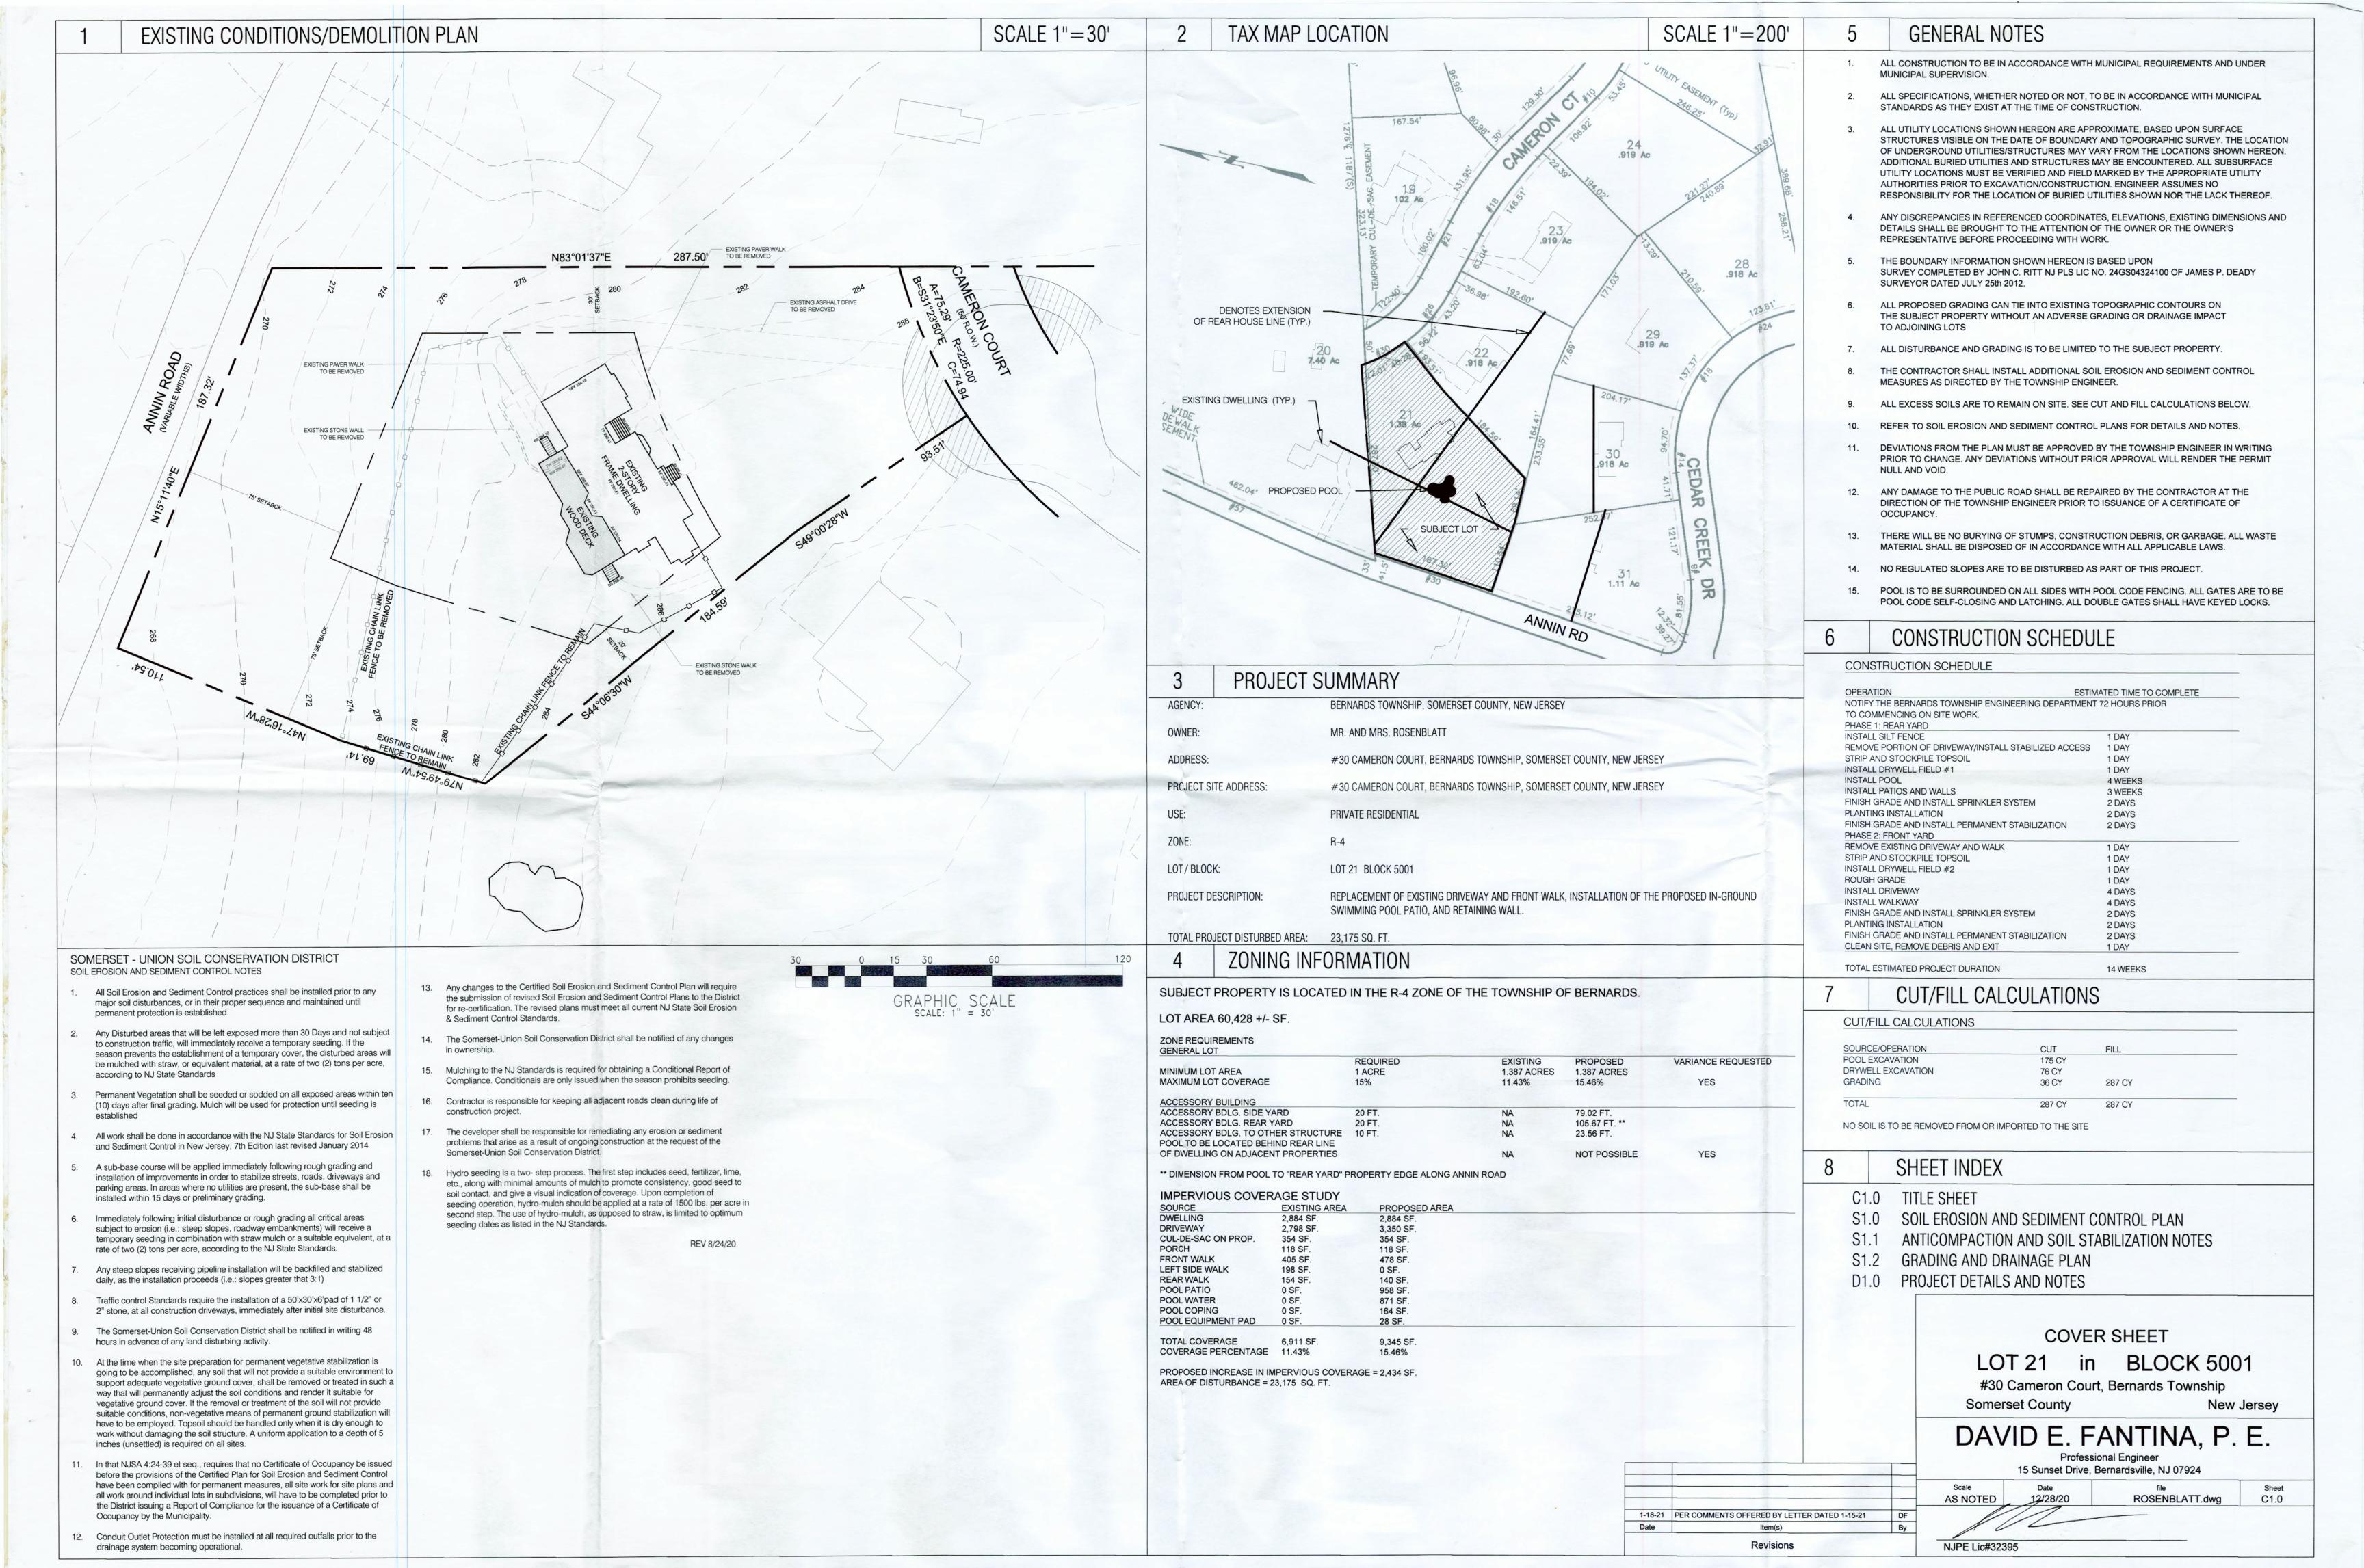

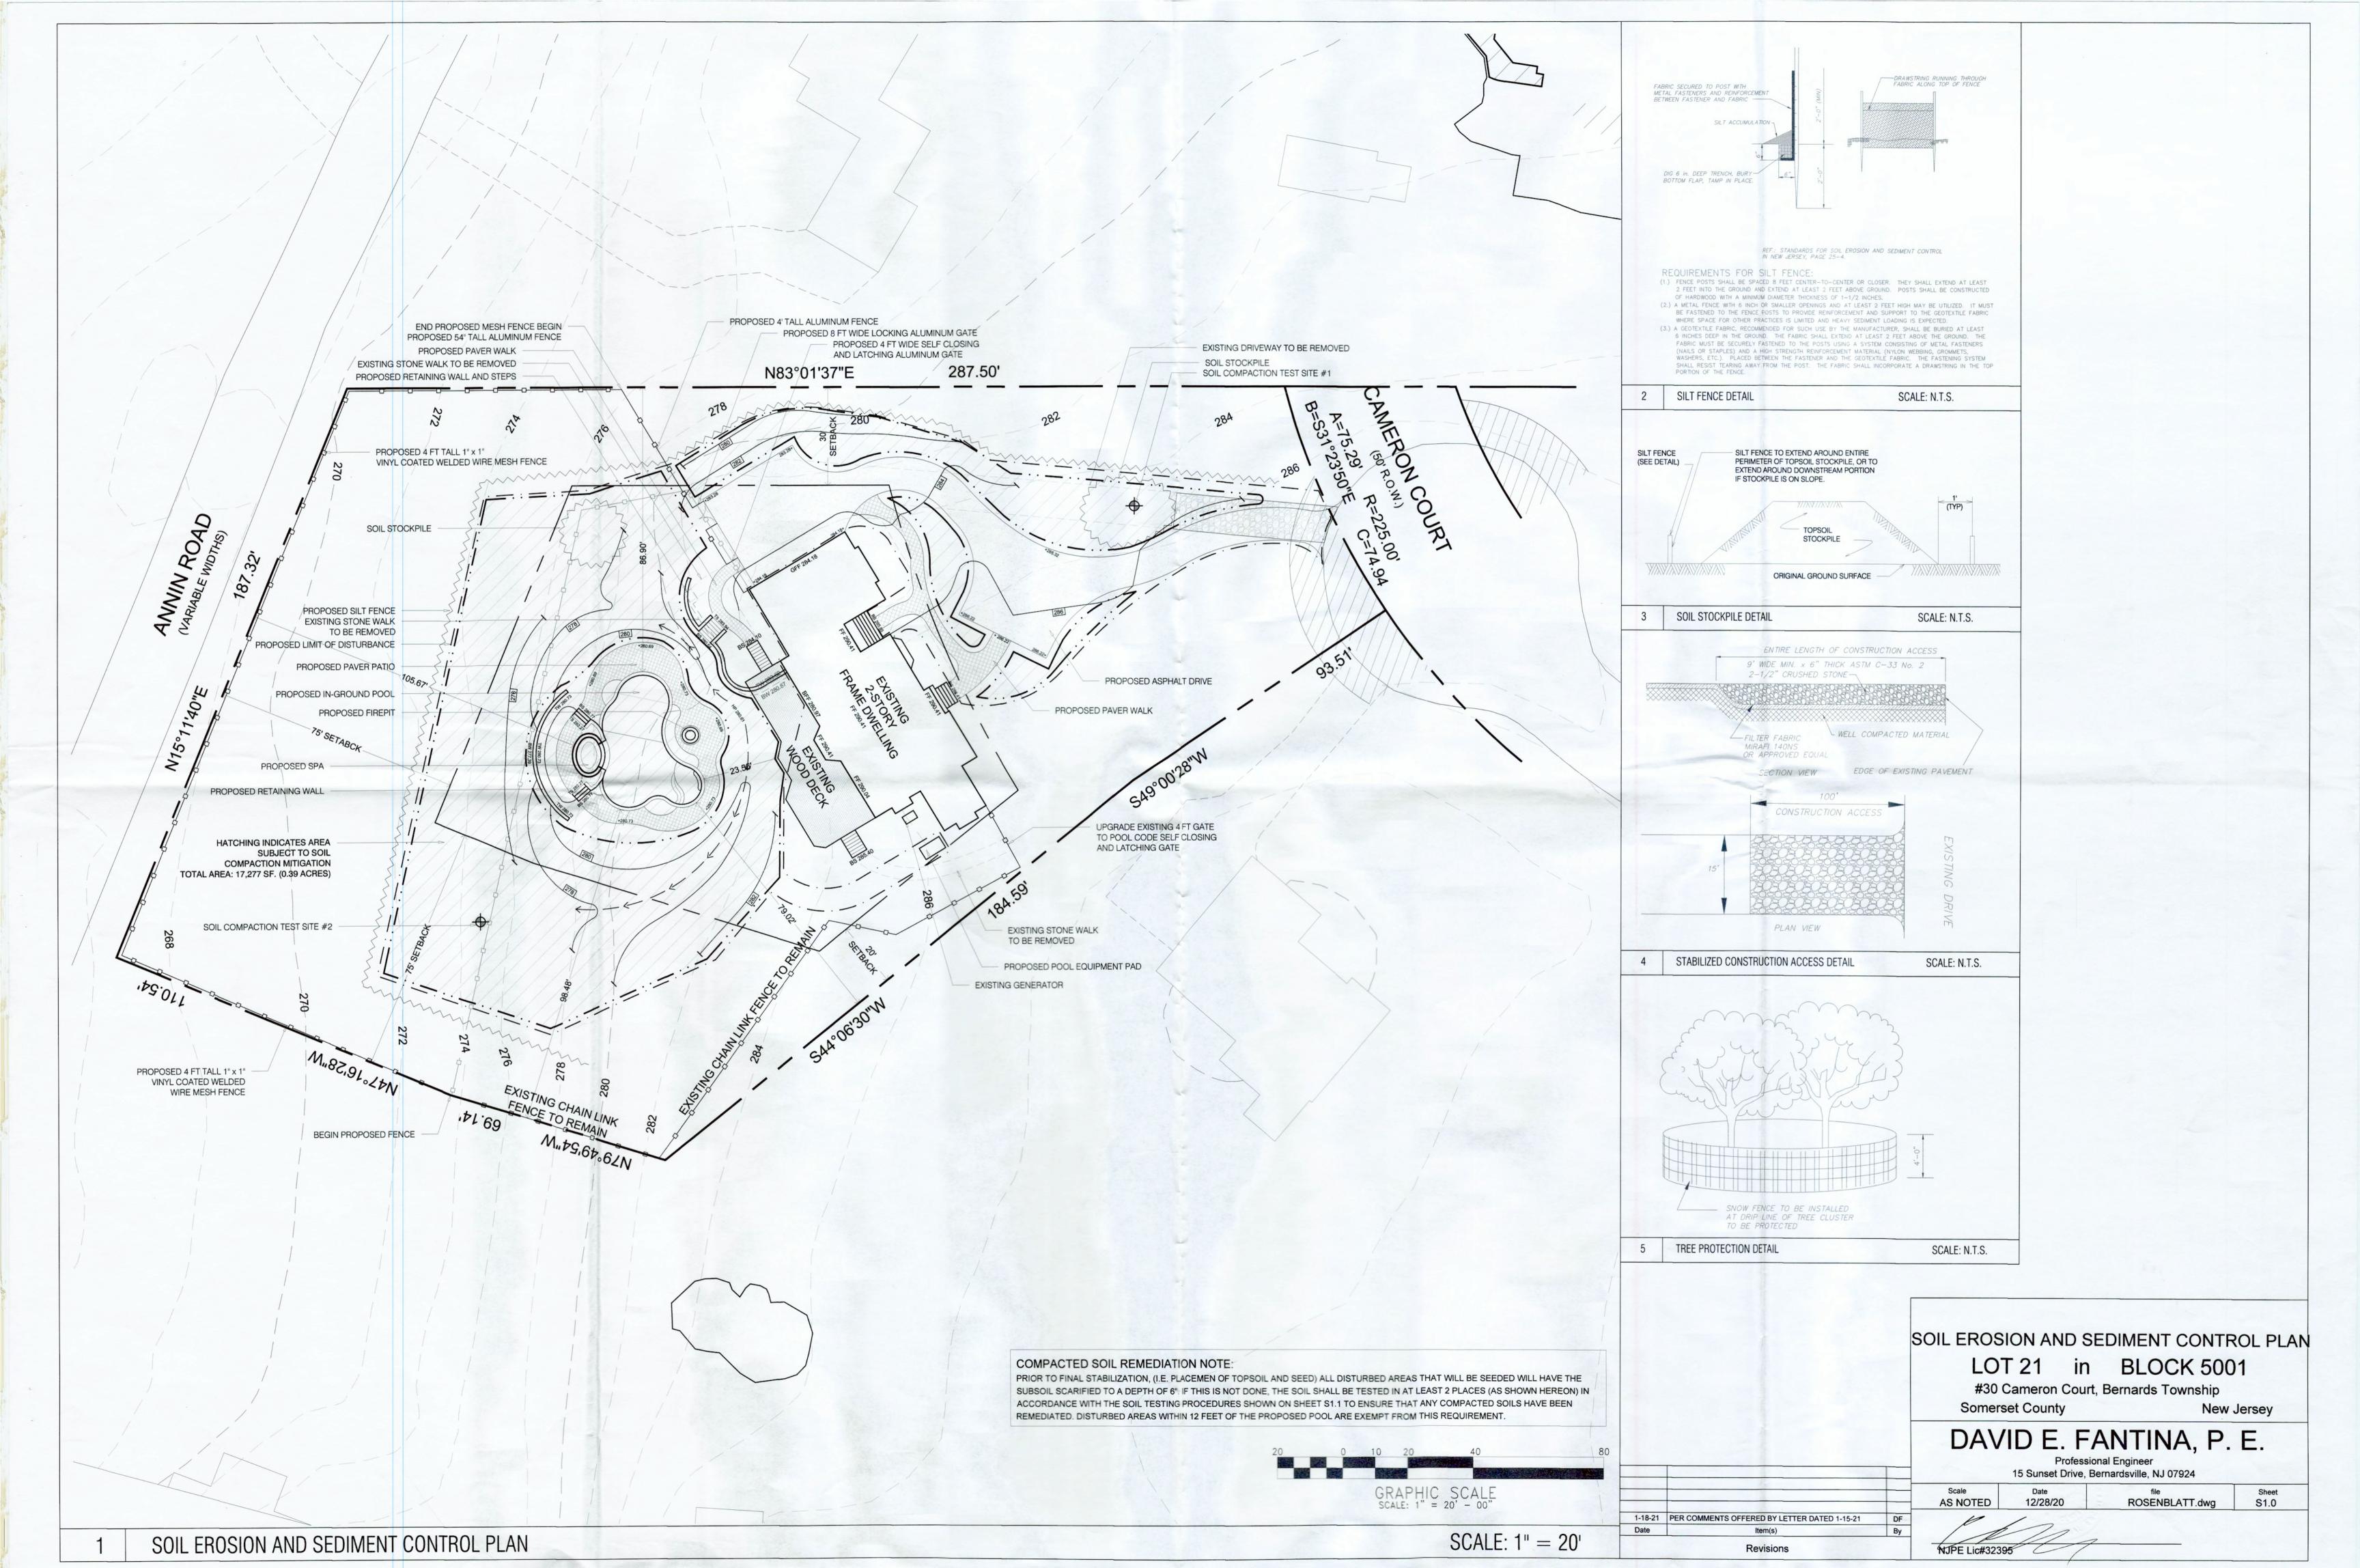

STANDARD FOR PERMANENT VEGETATIVE COVER FOR SOIL STABILIZATION

Methods and Materials 1. Site Preparation

- A. Grade as needed and feasible to permit the use of conventional equipment for seedbed preparation, seeding, mulch application, and mulch anchoring. All grading should be done in accordance with Standard for Land Grading.
- B. Immediately prior to seeding and topsoil application, the subsoil shall be evaluated for compaction in accordance with the Standard for Land Grading.
- C. Topsoil should be handled only when it is dry enough to work without damaging the soil structure. A uniform application to a depth of 5 inches (unsettled) is required on all sites. Topsoil shall be amended with organic matter, as needed, in accordance with the Standard for Topsoiling.
- D. Install needed erosion control practices or facilities such as diversions, grade-stabilization structures, channel stabilization measures, sediment basins, and waterways.

2. Seedbed Preparation

- A. Uniformly apply ground limestone and fertilizer to topsoil which has been spread and firmed, according to soil test recommendations such as offered by Rutgers Co-operative Extension Soil sample mailers are available from the local Rutgers Cooperative Extension offices (http://njaes.rutgers.edu/county/). Fertilizer shall be applied at the rate of 500 pounds per acre or 11 pounds per 1,000 square feet of 10-10-10 or equivalent with 50% water insoluble nitrogen unless a soil test indicates otherwise and incorporated into the surface 4 inches. If fertilizer is not incorporated, apply one-half the rate described above during seedbed preparation and repeat another one-half rate application of the same fertilizer within 3 to 5 weeks after seeding.
- B. Work lime and fertilizer into the topsoil as nearly as practical to a depth of 4 inches with a disc, spring-tooth harrow, or other suitable equipment. The final harrowing or disking operation should be on the general contour. Continue tillage until a reasonable uniform seedbed is prepared.
- C. High acid producing soil. Soils having a pH of 4 or less or containing iron sulfide shall be covered with a minimum of 12 inches of soil having a pH of 5 or more before initiating seedbed reparation. See Standard for Management of High Acid-Producing Soils for specific requirements.

3. Seeding

- A. SEE SEEDING SPECIFICATIONS ON THIS SHEET.

 Seed germination shall have been tested within 12 months of the planting date. No seed shall be accepted with a germination test date more than 12 months old unless retested.
- 1. Seeding rates specified are required when a report of compliance is requested prior to actual establishment of permanent vegetation. Up to 50% reduction in rates may be used when permanent vegetation is established prior to a report of compliance inspection. These rates apply to all methods of seeding. Establishing permanent vegetation means 80% vegetative coverage with the specified seed mixture for the seeded area and mowed once.
- 2. Warm-season mixtures are grasses and legumes which maximize growth at high temperatures, generally 85° F and above. See Table 4-3 mixtures 1 to 7. Planting rates for warm-season grasses shall be the amount of Pure Live Seed (PLS) as determined by germination testing results.
- Cool-season mixtures are grasses and legumes which maximize growth at temperatures below 85°F. Many grasses become active at 65°F. See Table 4-3, mixtures 8-20. Adjustment of planting rates to compensate for the amount of PLS is not required for cool season grasses.
- B. Conventional Seeding is performed by applying seed uniformly by hand, cyclone (centrifugal) seeder, drop seeder, drill or cultipacker seeder. Except for drilled, hydroseeded or cultipacked seedings, seed shall be incorporated into the soil within 24 hours of seedbed preparation to a depth of 1/4 to 1/2 inch, by raking or dragging. Depth of seed placement may be 1/4 inch deeper on coarse-textured soil.
- C. After seeding, firming the soil with a corrugated roller will assure good seed-to-soil contact, restore capillarity, and improve seedling emergence. This is the preferred method. When performed on the contour, sheet erosion will be minimized and water conservation on site will be maximized.
- D. Hydroseeding is a broadcast seeding method usually involving a truck, or trailer-mounted tank, with an agitation system and hydraulic pump for mixing seed, water and fertilizer and spraying the mix onto the prepared seedbed. Mulch shall not be included in the tank with seed. Shortfibered mulch may be applied with a hydroseeder following seeding. (also see Section 4-Mulching below). Hydroseeding is not a preferred seeding method because seed and fertilizer are applied to the surface and not incorporated into the soil. When poor seed to soil contact occurs, there is a reduced seed germination and growth.

4. Mulching

Mulching

Mulching is required on all seeding. Mulch will protect against erosion before grass is established and will promote faster and earlier establishment. The existence of vegetation sufficient to control soil erosion shall be deemed compliance with this mulching requirement.

- A. Straw or Hay. Unrotted small grain straw, hay free of seeds, to be applied at the rate of 1-1/2 to 2 tons per acre (70 to 90 pounds per 1,000 square feet), except that where a crimper is used instead of a liquid mulch-binder (tackifying or adhesive agent), the rate of application is 3 tons per acre. Mulch chopper-blowers must not grind the mulch. Hay mulch is not recommended for establishing fine turf or lawns due to the presence of weed seed.

 Application Spread mulch uniformly by hand or mechanically so that at least 85% of the soil surface is covered. For uniform distribution of hand-spread mulch, divide area into approximately 1,000 square feet sections and distribute 70 to 90 pounds within each section.

 Anchoring shall be accomplished immediately after placement to minimize loss by wind or water. This may be done by one of the following methods, depending upon the size of the area, steepness of slopes, and costs.
 - Peg and Twine. Drive 8 to 10 inch wooden pegs to within 2 to 3 inches of the soil surface every 4 feet in all directions. Stakes may be driven before or after applying mulch. Secure mulch to soil surface by stretching twine between pegs in a criss-cross and a square pattern. Secure twine around each peg with two or more round turns.
 - Mulch Nettings Staple paper, jute, cotton, or plastic nettings to the soil surface. Use a degradable netting in areas to be mowed.
 - 3. Crimper (mulch anchoring coulter tool) A tractor-drawn implement, somewhat like a disc harrow, especially designed to push or cut some of the broadcast long fiber mulch 3 to 4 inches into the soil so as to anchor it and leave part standing upright. This technique is limited to areas traversable by a tractor, which must operate on the contour of slopes. Straw mulch rate must be 3 tons per acre. No tackifying or adhesive agent is required.
 - 4. Liquid Mulch-Binders May be used to anchor salt hay, hay or straw mulch.
 - a. Applications should be heavier at edges where wind may catch the mulch, in valleys, and at crests of banks. The remainder of the area should be uniform in appearance.
 - b. Use one of the following:
 (1) Organic and Vegetable Based Binders Naturally occurring, powder-based,

hydrophilic materials when mixed with water formulates a gel and when applied to mulch under satisfactory curing conditions will form membraned networks of insoluble polymers. The vegetable gel shall be physiologically harmless and not result in a phytotoxic effect or impede growth of turf grass. Use at rates and weather conditions as recommended by the manufacturer to anchor mulch materials. Many new products are available, some of which may need further evaluation for use in this state.

(2) Synthetic Binders - High polymer synthetic emulsion, miscible with water when diluted and, following application of mulch, drying and curing, shall no longer be soluble or dispersible in water. Binder shall be applied at rates recommended by the manufacturer and remain tacky until germination of grass.

Note: All names given above are registered trade names. This does not constitute a recommendation of these products to the exclusion of other products.

- B. Wood-fiber or paper-fiber mulch shall be made from wood, plant fibers or paper containing no growth or germination inhibiting materials, used at the rate of 1,500 pounds per acre (or as recommended by the product manufacturer) and may be applied by a hydroseeder. Mulch shall not be mixed in the tank with seed. Use is limited to flatter slopes and during optimum seeding periods in spring and fall.
- C. Pelletized mulch compressed and extruded paper and/or wood fiber product, which may contain co-polymers, tackifiers, fertilizers, and coloring agents. The dry pellets, when applied to a seeded area and watered, form a mulch mat. Pelletized mulch shall be applied in accordance with the manufacturer's recommendations. Mulch may be applied by hand or mechanical spreader at the rate of 60-75 lbs/1,000 square feet and activated with 0.2 to 0.4 inches of water. This material has been found to be beneficial for use on small lawn or renovation areas, seeded areas where weedseed free mulch is desired, or on sites where straw mulch and tackifier agent are not practical or desirable. Applying the full 0.2 to 0.4 inches of water after spreading pelletized mulch on the seed bed is extremely important for sufficient activation and expansion of the mulch to provide soil coverage.
- 5. Irrigation (where feasible)

If soil moisture is deficient supply new seeding with adequate water (a minimum of 1/4 inch applied up to twice a day until vegetation is well established). This is especially true when seedings are made in abnormally dry or hot weather or on droughty sites.

6. Topdressing

Since soil organic matter content and slow release nitrogen fertilizer (water insoluble) are prescribed in Section 2A - Seedbed Preparation in this Standard, no follow-up of topdressing is mandatory. An exception may be made where gross nitrogen deficiency exists in the soil to the extent that turf failure may develop. In that instance, topdress with 10-10-10 or equivalent at 300 pounds per acre or 7 pounds per 1,000 square feet every 3 to 5 weeks until the gross nitrogen deficiency in the turf is ameliorated.

7. Establishing Permanent Vegetative Stabilization
The quality of permanent vegetation rests with the contractor. The timing of seeding, preparing the seedbed, applying nutrients, mulch and other management are essential. The seed application rates in Table 4-3 are required when a Report of Compliance is requested prior to actual establishment of permanent vegetation. Up to 50% reduction in application rates may be used when permanent vegetation is established prior to requesting a Report of Compliance from the district. These rates apply to all methods of seeding. Establishing permanent vegetation means 80% vegetative cover (of the seeded species) and mowed once. Note this designation of mowed once does not guarantee the permanency of the turf should other maintenance factors be neglected or otherwise mismanaged.

SEEDING SPECIFICATIONS

- TEMPORARY STABILIZATION SPECIFICATIONS
- Apply ground limestone at a rate of 90 lbs/1000 SF.
 Apply fertilizer (10-20-10) at a rate of 11 lbs/1000 SF, and work into the soil 4" deep.
- Apply seed mixture: Perennial ryegrass at 100 lbs/acre and annual ryegrass at 100 lbs/acre or
- 4. Mulch with unrotted, seed free salt hay or small grain straw immediately after seeding. Apply at a rate
- of 70 to 90 lbs/1000 SF.
- Plant seed between March 1 & May 15 or between August 15 & October 1, if possible.

PERMANENT STABILIZATION SPECIFICATIONS

- Apply topsoil to a depth of 5" (unsettled) on all graded areas.
- Apply ground limestone at a rate of 90 lbs/1000 SF.
- 3. Apply fertilizer (10-10-10) at a rate of 11 lbs/1000 SF.

or between August 15 & October 1, if possible.

- Apply seed mixture: Hard fescue 130 lbs/acre, Chewings Fescue at 45 lbs/acre, Strong Creeping Red
 Fescue at 45 lbs/acre, and Perennial Ryegrass at 10 lbs/acre.
- 6. Mulch with unrotted seed free salt hay or small grain straw immediately after seeding. Apply at a rate
- of 70 to 90 lbs/1000 SF. according to NJ Standards.

 7. Anchor mulch with organic, vegtable-based or synthetic binders. Other approved methods
 (i.e. peg and twine, or mulch netting) may be used. If possible, plant between March 1 & May 15

STANDARD FOR TEMPORARY VEGETATIVE COVER FOR SOIL STABILIZATION

Methods and Materials 1. Site Preparation

- A. Grade as needed and feasible to permit the use of conventional equipment for seedbed preparation, seeding, mulch application, and mulch anchoring. All grading should be done in accordance with Standards for Land Grading, pg. 19-1.
- accordance with Standards for Land Grading, pg. 19-1.
 Install needed erosion control practices or facilities such as diversions, grade stabilization structures, channel stabilization measures, sediment basins, and waterways. See Standards 11
- C. Immediately prior to seeding, the surface should be scarified 6" to 12" where there has been soil compaction. This practice is permissible only where there is no danger to underground utilities (cables, irrigation systems, etc.).

2. Seedbed Preparation

- A. Apply ground limestone and fertilizer according to soil test recommendations such as offered by Rutgers Co-operative Extension. Soil sample mailers are available from the local Rutgers Cooperative Extension offices. Fertilizer shall be applied at the rate of 500 pounds per acre or 11 pounds per 1,000 square feet of 10-20-10 or equivalent with 50% water insoluble nitrogen unless a soil test indicates otherwise. Apply limestone at the rate of 2 tons/acre unless soil testing indicates otherwise. Calcium carbonate is the equivalent and standard for measuring the ability of liming materials to neutralize soil acidity and supply calcium and magnesium to grasses and legumes
- materials to neutralize soil acidity and supply calcium and magnesium to grasses and legumes.

 B. Work lime and fertilizer into the soil as nearly as practical to a depth of 4 inches with a disc, springtooth harrow, or other suitable equipment. The final harrowing or disking operation should be on the general contour. Continue tillage until a reasonable uniform seedbed is prepared.
- C. Inspect seedbed just before seeding. If traffic has left the soil compacted, the area must be retilled in accordance with the above.
- Soils high in sulfides or having a pH of 4 or less refer to Standard for Management of High Acid Producing Soils, pg. 1-1.

3. Seeding

A. SEE SEEDING SPECIFICATIONS ON THIS SHEET.

- B. Conventional Seeding. Apply seed uniformly by hand, cyclone (centrifugal) seeder, drop seeder, drill or cultipacker seeder. Except for drilled, hydroseeded or cultipacked seedings, seed shall be incorporated into the soil, to a depth of 1/4 to 1/2 inch, by raking or dragging. Depth of seed placement may be 1/4 inch deeper on coarse textured soil.
- C. Hydroseeding is a broadcast seeding method usually involving a truck or trailer mounted tank, with an agitation system and hydraulic pump for mixing seed, water and fertilizer and spraying the mix onto the prepared seedbed. Mulch shall not be included in the tank with seed. Short fibered mulch may be applied with a hydroseeder following seeding. (also see Section IV Mulching) Hydroseeding is not a preferred seeding method because seed and fertilizer are applied to the surface and not incorporated into the soil. Poor seed to soil contact occurs reducing seed germination and growth. Hydroseeding may be used for areas too steep for conventional equipment to traverse or too obstructed with rocks, stumps, etc.
- D. After seeding, firming the soil with a corrugated roller will assure good seed-to-soil contact, restore capillarity, and improve seedling emergence. This is the preferred method. When performed on the contour, sheet erosion will be minimized and water conservation on site will be maximized.

4. Mulching

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 feet in all directions. Stakes may be driven before or after applying mulch. Secure mulch to soil
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4. Liquid Mulch-Binders. - May be used to anchor hay or straw mulch.

- Applications should be heavier at edges where wind may catch the mulch, in valleys, and at crests of banks. The remainder of the area should be uniform in appearance.
- b. Use one of the following:

(1) Organic and Vegetable Based Binders – Naturally occurring, powder based, hydrophilic materials when mixed with water formulates a gel and when applied to mulch under satisfactory curing conditions will form membraned networks of insoluble polymers. The vegetable gel shall be physiologically harmless and not result in a phytotoxic effect or impede growth of turfgrass. Use at rates and weather conditions as recommended by the manufacturer to anchor mulch materials. Many new products are available, some of which may need further evaluation for use in this state.

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- C. Pelletized mulch. Compressed and extruded paper and/or wood fiber product, which may contain co-polymers, tackifiers, fertilizers and coloring agents. The dry pellets, when applied to a seeded area and watered, forma mulch mat. Pelletized mulch shall be applies in accordance with the manufacturers recommendations. Mulch may be applied by hand or mechanical spreader at the rate of 60-75 lbs./1,000 square feet and activated with 0.2 to 0.4 inches of water. This material has bee found to be beneficial for use on small lawn or renovation areas, seeded areas where weed-seed free mulch is desired or on sites where straw mulch and tackifier agent are not practical or desirable. Applying the full 0.2 to 0.4 inches of water after spreading pelletized mulch on the seed bed is extremely important for sufficient activation and expansion of the mulch to provide soil coverage.

Soil De-compaction and Testing Requirements

Soil Compaction Testing Requirements

1. Subgrade soils <u>prior to the application of topsoil</u> (see permanent seeding and stabilization notes for topsoil requirements) shall be free of excessive compaction to a depth of 6.0 inches to enhance the establishment of permanent vegetative cover.

2. Areas of the site which are subject to compaction testing and/or mitigation are **graphically denoted** on the certified soil erosion control plan.

3. <u>Compaction testing locations</u> are denoted on the plan. A copy of the plan or portion of the plan shall be used to mark locations of tests, and attached to the compaction remediation form, available from the local soil conservation district. This form must be filled out and submitted prior to receiving a certificate of compliance from the district.

4. In the event that testing indicates compaction in excess of the maximum thresholds indicated for the simplified testing methods (see details below), the contractor/owner shall have the option to perform either (1) compaction mitigation over the entire mitigation area denoted on the plan (excluding exempt areas), or (2) perform additional, more detailed testing to establish the limits of excessive compaction whereupon only the excessively compacted areas would require compaction mitigation. Additional detailed testing shall be performed by a trained, licensed professional.

Compaction Testing Methods

- A. Probing Wire Test (see detail)
- B. Hand-held Penetrometer Test (see detail)
 C .Tube Bulk Density Test (licensed professional engineer required)
- D. Nuclear Density Test (licensed professional engineer required)

Note: Additional testing methods which conform to ASTM standards and specifications, and which produce a dry weight, soil bulk density measurement may be allowed subject to District approval.


<u>Soil compaction testing is not required</u> if/when subsoil compaction remediation (scarification/tillage (6" minimum depth) or similar) is proposed as part of the sequence of construction.


Procedures for Soil Compaction Mitigation

Procedures shall be used to mitigate excessive soil compaction <u>prior to placement of topsoil</u> and establishment of permanent vegetative cover.

Restoration of compacted soils shall be through deep scarification/tillage (6" minimum depth) where there is no danger to underground utilities (cables, irrigation systems, etc.). In the alternative, another method as specified by a New Jersey Licensed Professional Engineer maybe substituted subject to District Approval.

Simplified Testing Methods

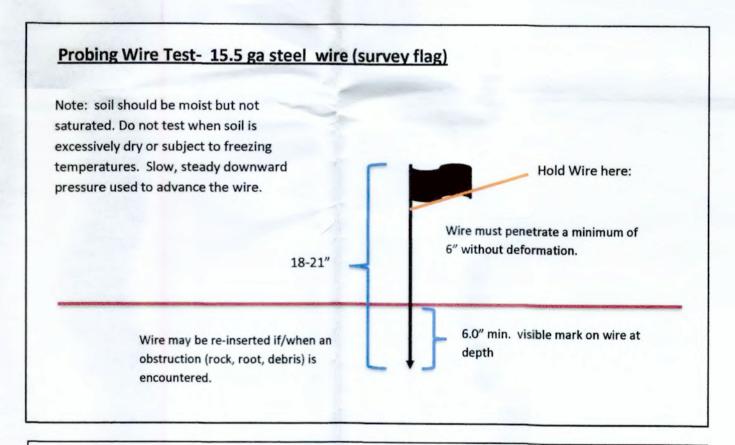

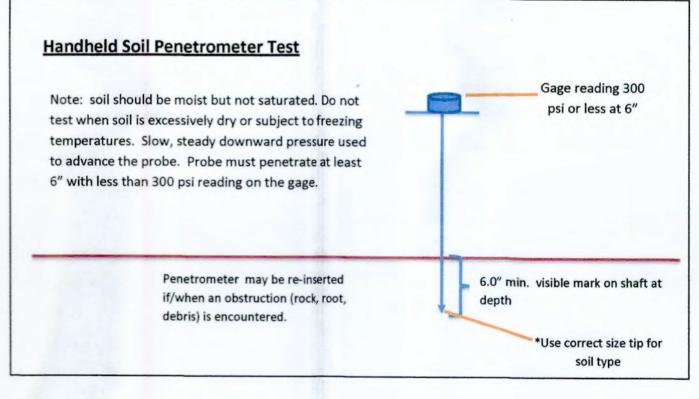

Revisions

STABILIZATION AND COMPACTION MITIGATION NOTES AND DETAILS

New Jersey

LOT 21 in BLOCK 5001 #30 Cameron Court, Bernards Township

DAVID E. FANTINA, P. E.

Professional Engineer

15 Support Drive, Perperdeville, NJ 07024

Professional Engineer
15 Sunset Drive, Bernardsville, NJ 07924

Scale Date file Sheet
AS NOTED 12/28/20 ROSENBLATT.dwg S1.1

1-18-21 PER COMMENTS OFFERED BY LETTER DATED 1-15-21 DF
Date Item(s) By

NSPE Lic#32395

Somerset County

